



Site Context Plan

SCALE 1:200

General Notes:

These drawings shall be read in conjunction with all relevant structural and all other consultants drawings/details and with any other written instructions issued in the course of the contract. Site plan drawings/details and any other relevant documentation issued by the relevant Building Surveyor prior to the commencement of any works. Report all discrepancies to the office & submit a material, work practice, variation or the like is not an acknowledgement.

These plans have been prepared for the exclusive use by the Client of Dawes Design & Drafting Group (The Designer) for the purpose expressly noted to the Designer. Any other person who uses or relies on these plans without the Designer's written consent does so at their own risk and no responsibility is accepted by the Designer for the use of these plans - all other measurements in millimetres u.n.t. Figure dimensions take precedence over scaled dimensions.

The Builder and Subcontractors shall check and verify all dimensions, setbacks, levels and specifications and all other relevant documentation prior to the commencement of any works. Report all discrepancies to the office & submit a material, work practice, variation or the like is not an acknowledgement.

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No.	Revision Description	Date:

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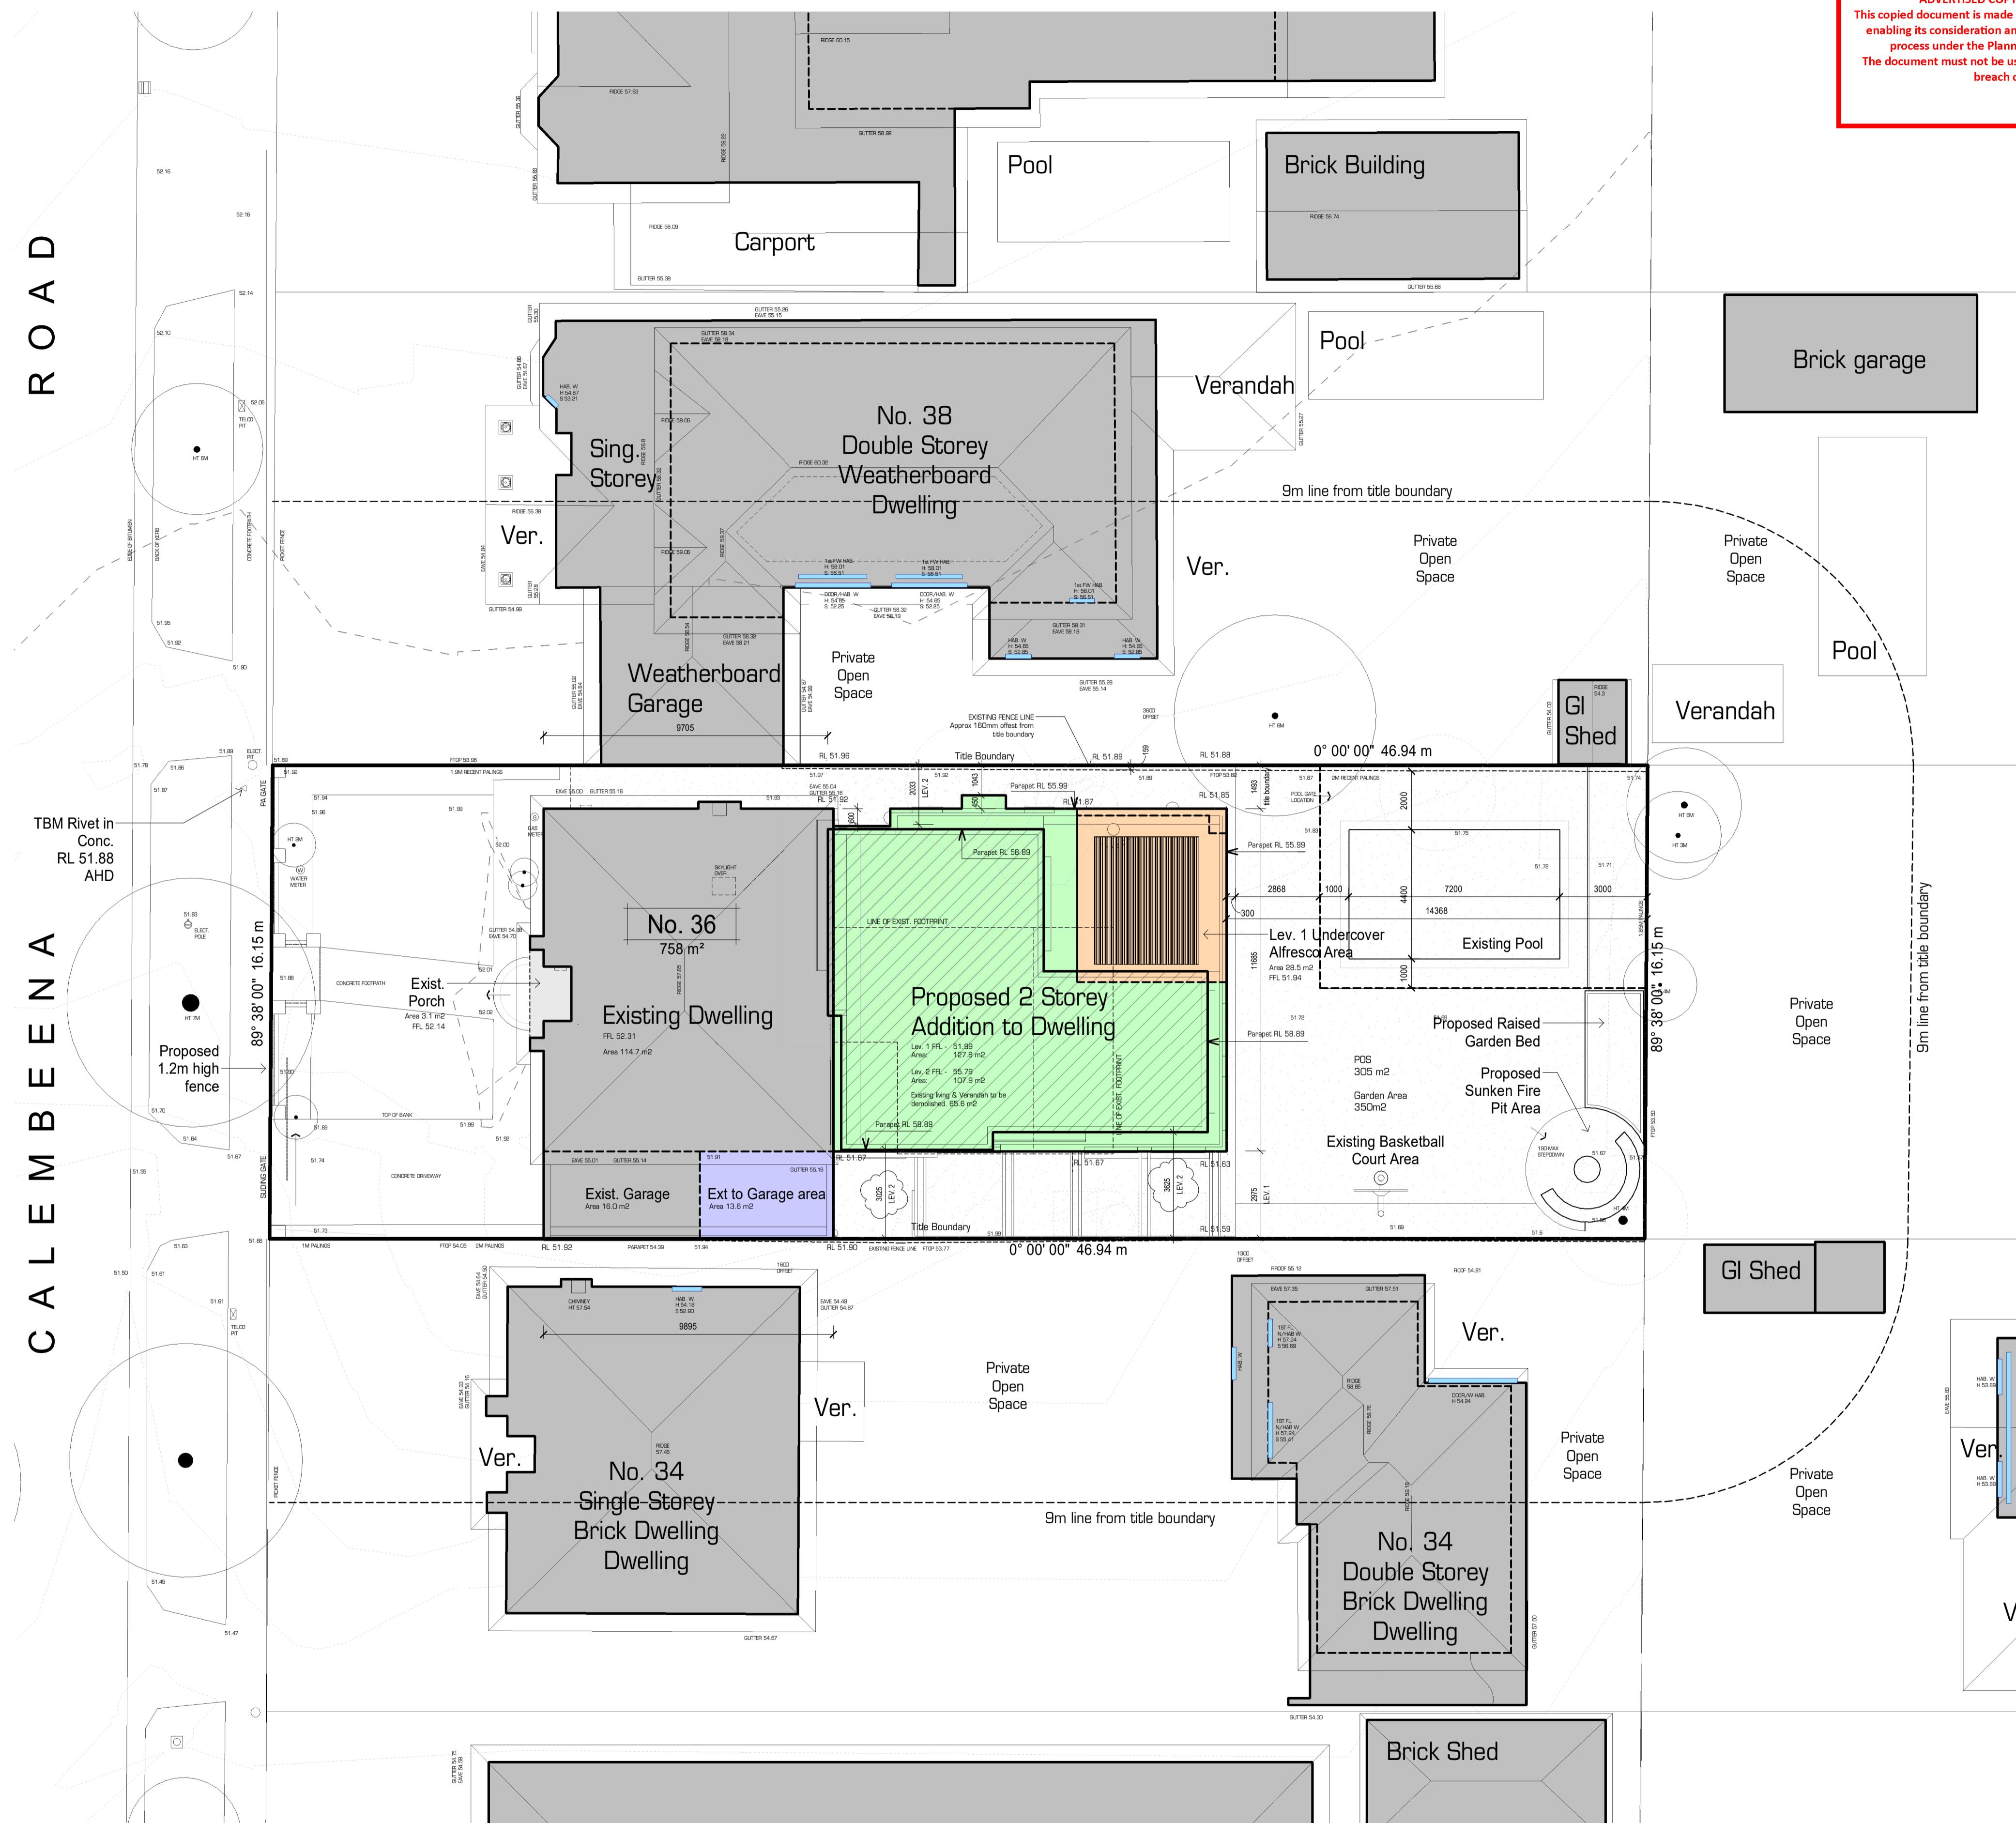
DESIGN: Troy Dawes DPA0574
 DRAWN BY: Author
 DATE: 18/11/2024 10:27:40 AM
 SCALE: As indicated

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 SHEET NO:
 TP01
 D01
 2649

ISSUE: Town Planning Issue F - 14/11/2024

ROAD

CALEMBEENA



All materials and work practices shall comply with, but not limited to the Building Regulations 2006, the Building Code of Australia and all relevant current Australian Standards (as amended) referred to therein. These drawings shall be read in conjunction with all relevant structural and all other consultants drawings/details and with any other written instructions issued in the course of the contract.

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Site Development Plan

SCALE 1 : 125


Lot: Lot 105 (No. 36)
PS: LP 6430
Parish: -
Volume: -
Folio: -
Area: 758 m²

Note: Owner's responsibility to recognise existing or future vegetation (including neighbouring properties) and its potential effect on soil moisture. Where necessary existing trees on or adjacent to proposed building alignment are to be removed or vertical root barriers provided in accordance with soil report recommendations.

DESIGN: Troy Davies DPAD 574
DRAWN BY: Author
DATE: 18/11/2024 10:27:50 AM
SCALE: As indicated

Sheet No: TP02
Page No: 2649

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Site Design Information:

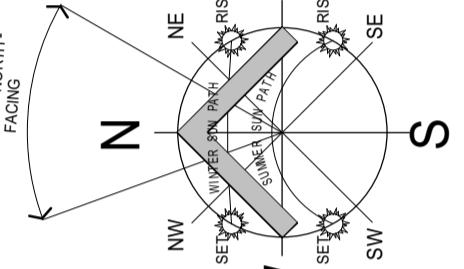Authorities / Consultants:
Municipality: -
Building Surveyor: -
Relevant Building Surveyor: -
Consulting Structural Engineer: -
Geotechnical Engineer: -

Site Classification:
Site classification in Class: -
Refer to soil report No: -
By: -

Design gust wind speed / wind classification:
Building seddams to be provided in accordance with AS1684-2010 for an assumed design gust wind speed / wind classification. Refer to confirmation on site by Relevant Building Surveyor at first inspection refer to AS1684 for construction requirements.

Climate Zone:
Climate zone for thermal design / thermal performance assessment: -


Corrosion protection of bulk structural members:
Provide corrosion protection of bulk structural steel members such as steel plate, sheet angles, connectors, access ladders (other than wall ties) in accordance with BCA Volume 2 Table 3.2.2 suitable for an Environment classification.

Corrosion protection for sheet roofing:
Provide corrosion protection for sheet roofing in accordance with BCA Volume 2 Table 3.5.1.1a suitable for an Environment classification.

Area Analysis:

EXISTING RESIDENCE	159.8 m ²	31.6 m ²	16.5 m ²	16.0 m ²	8.0 m ²
Existing Living	-	-	-	-	-
Existing Porch	-	-	-	-	-
Existing Garage	-	-	-	-	-
Existing Rear Ver.	-	-	-	-	-
Total Existing Footprint	215.8 m ²	-	-	-	-
(Living & Ver. area to be deleted)	65.6 m ²	-	-	-	-
ADDITION	159.8 m ²	31.6 m ²	16.5 m ²	16.0 m ²	8.0 m ²
LEVEL: 1	-	-	-	-	-
Proposed Living	159.8 m ²	-	-	-	-
Proposed Outdoor Ent.	31.6 m ²	-	-	-	-
Proposed Garage	16.5 m ²	-	-	-	-
LEVEL: 2	-	-	-	-	-
Proposed Living	107.9 m ²	-	-	-	-
TOTAL PROPOSED RESIDENCE	259.7 m ²	31.6 m ²	16.5 m ²	16.0 m ²	8.0 m ²
LEVEL: 1	259.7 m ²	31.6 m ²	16.5 m ²	16.0 m ²	8.0 m ²
Living	259.7 m ²	31.6 m ²	16.5 m ²	16.0 m ²	8.0 m ²
Front Porch	31.6 m ²	-	-	-	-
Outdoor Entertaining	16.5 m ²	-	-	-	-
Garage	16.0 m ²	-	-	-	-
Carpent	8.0 m ²	-	-	-	-
Total	364.7 m ²	-	-	-	-
LEVEL: 2	107.9 m ²	-	-	-	-
Living	107.9 m ²	-	-	-	-
Total Building Area (under roof)	472.6 m ²	-	-	-	-
Area of site	384.7 m ²	-	-	-	-
Site coverage - Footprint	758.2 m ²	-	-	-	-
Site Perim - Footprint, drive & paths	400.2 m ²	-	-	-	-
Private Open Space - Garden Area	305.2 m ²	-	-	-	-
Total	350.2 m ²	-	-	-	-


Site Legend:

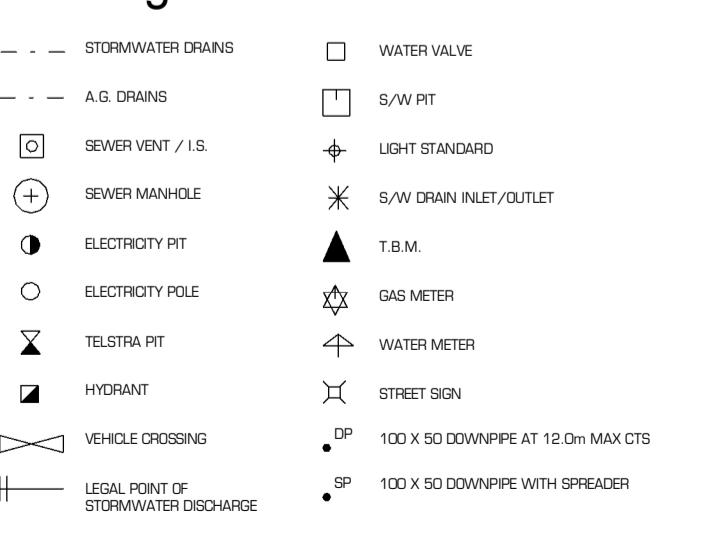




Shadow Plan - 10am

SCALE 1 : 200

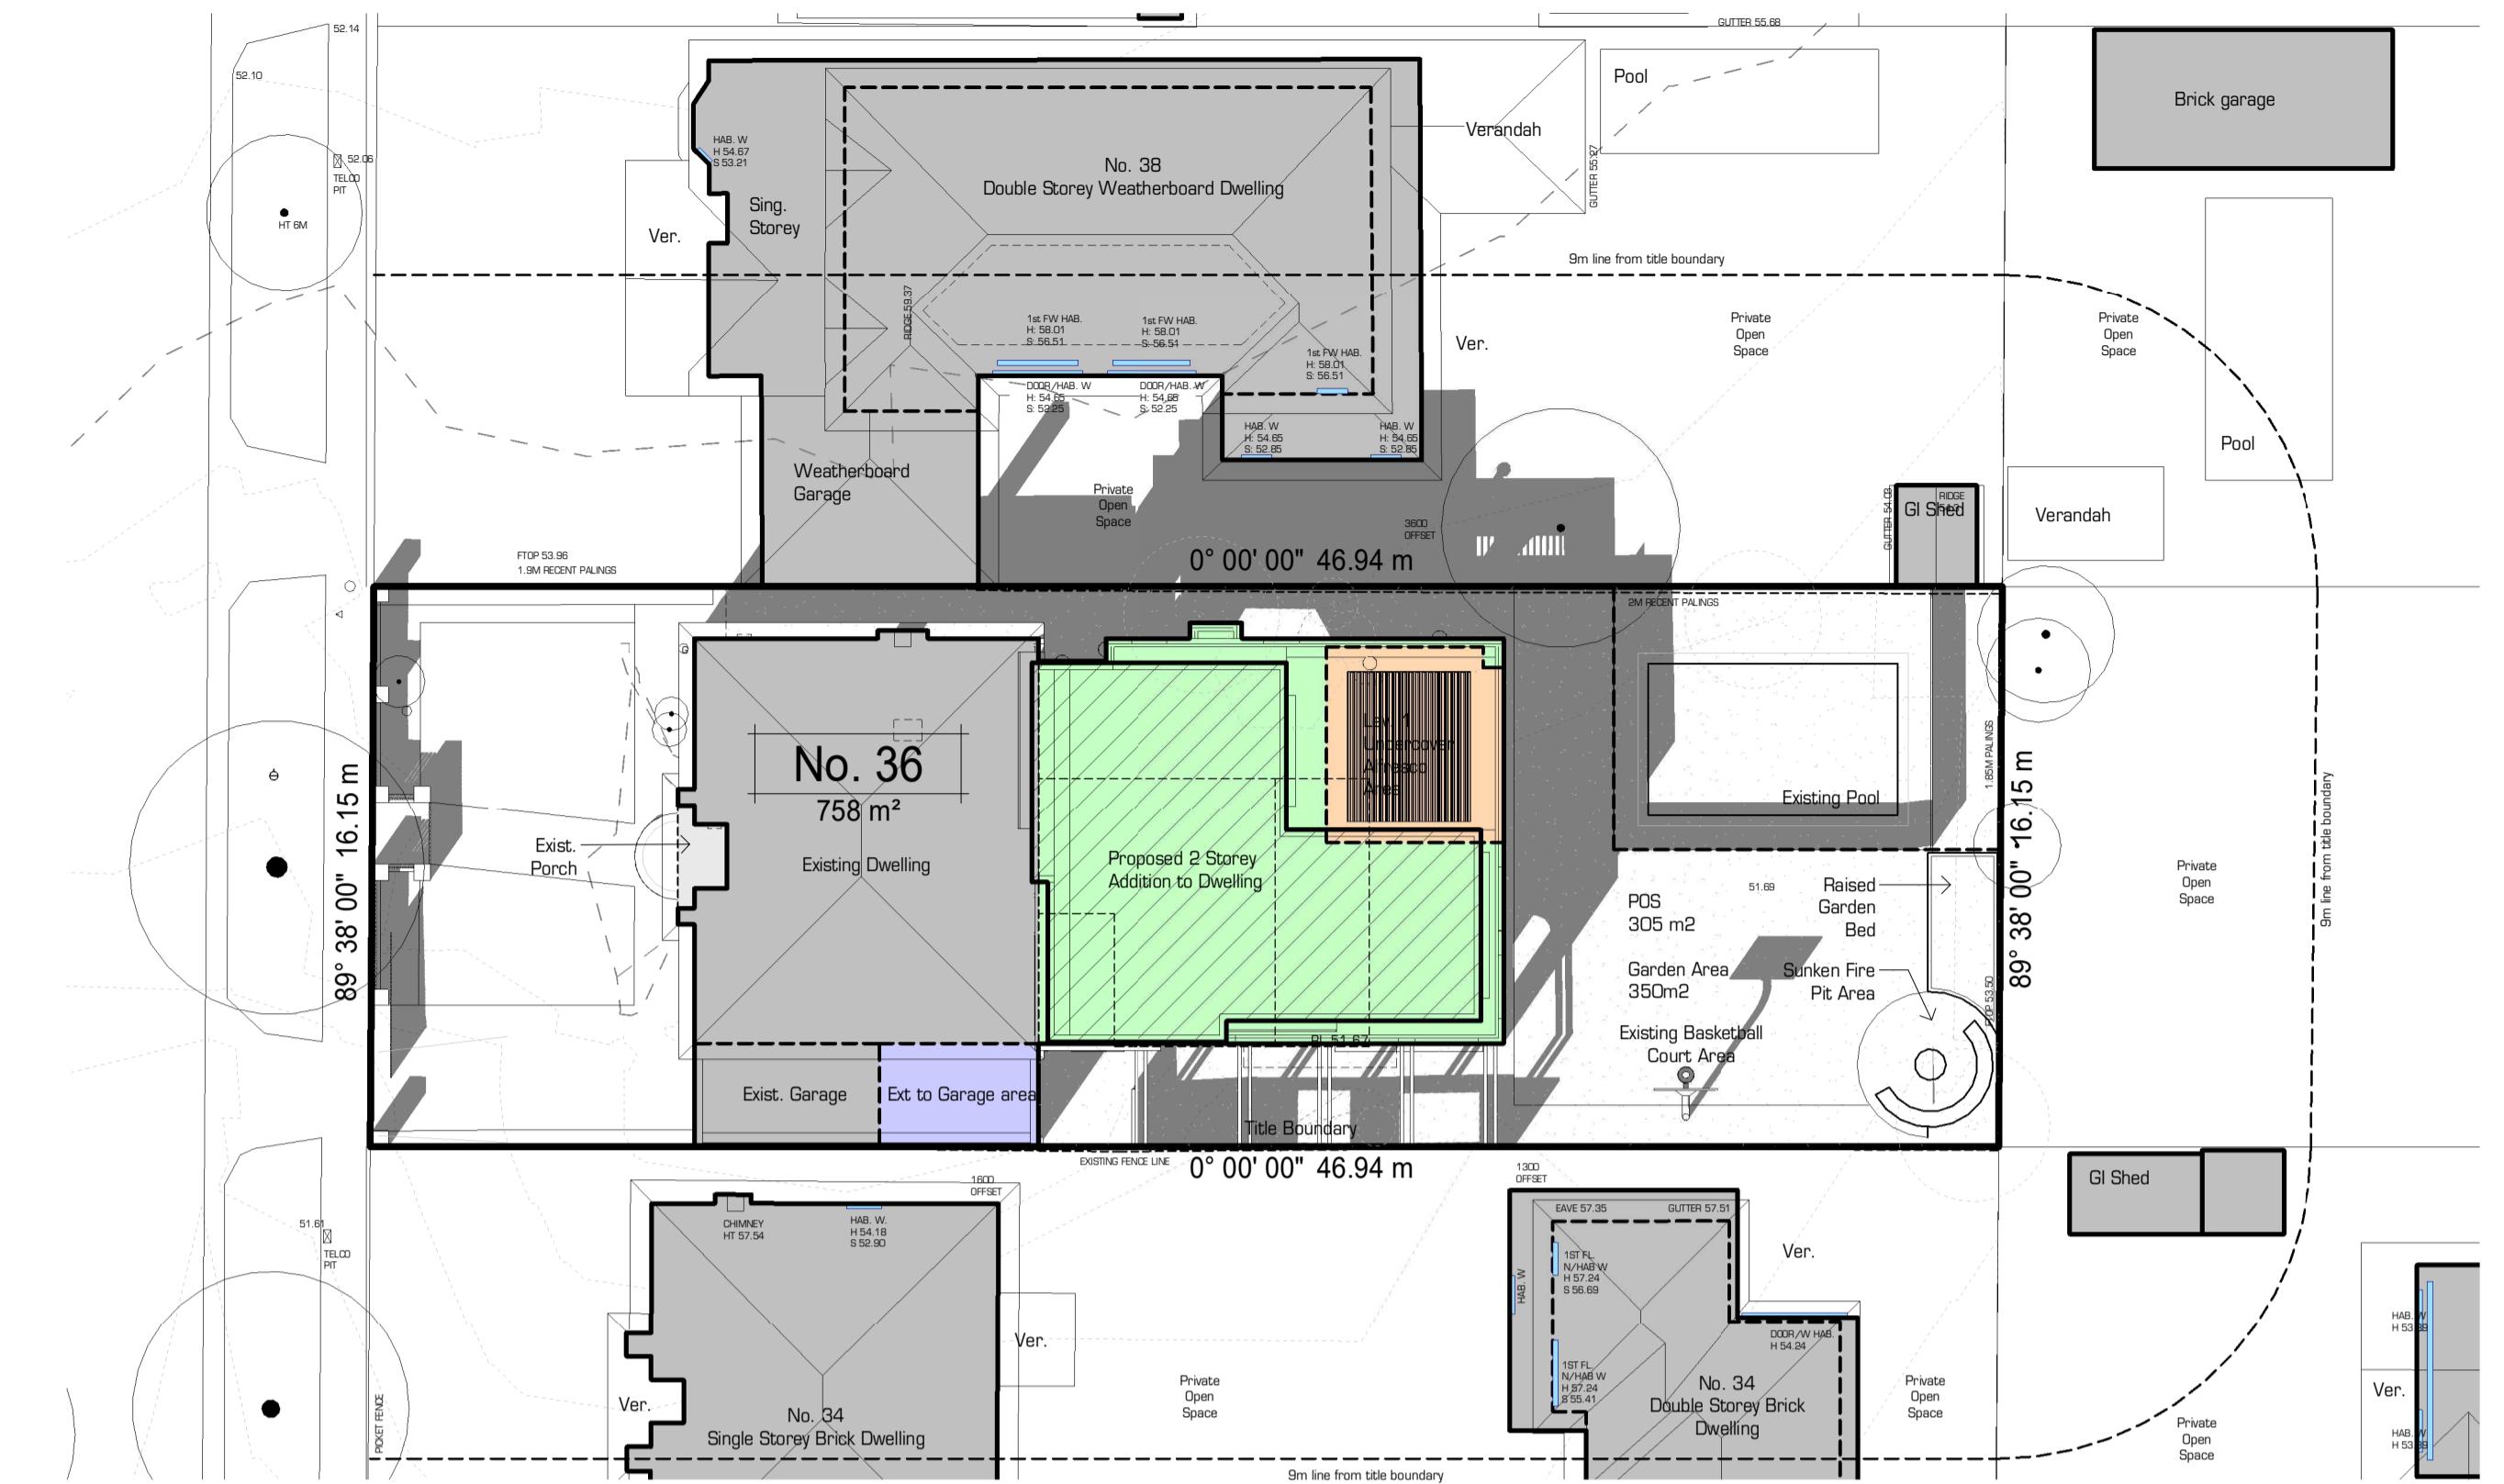

Shadow Plan - 3pm


SCALE 1 : 200

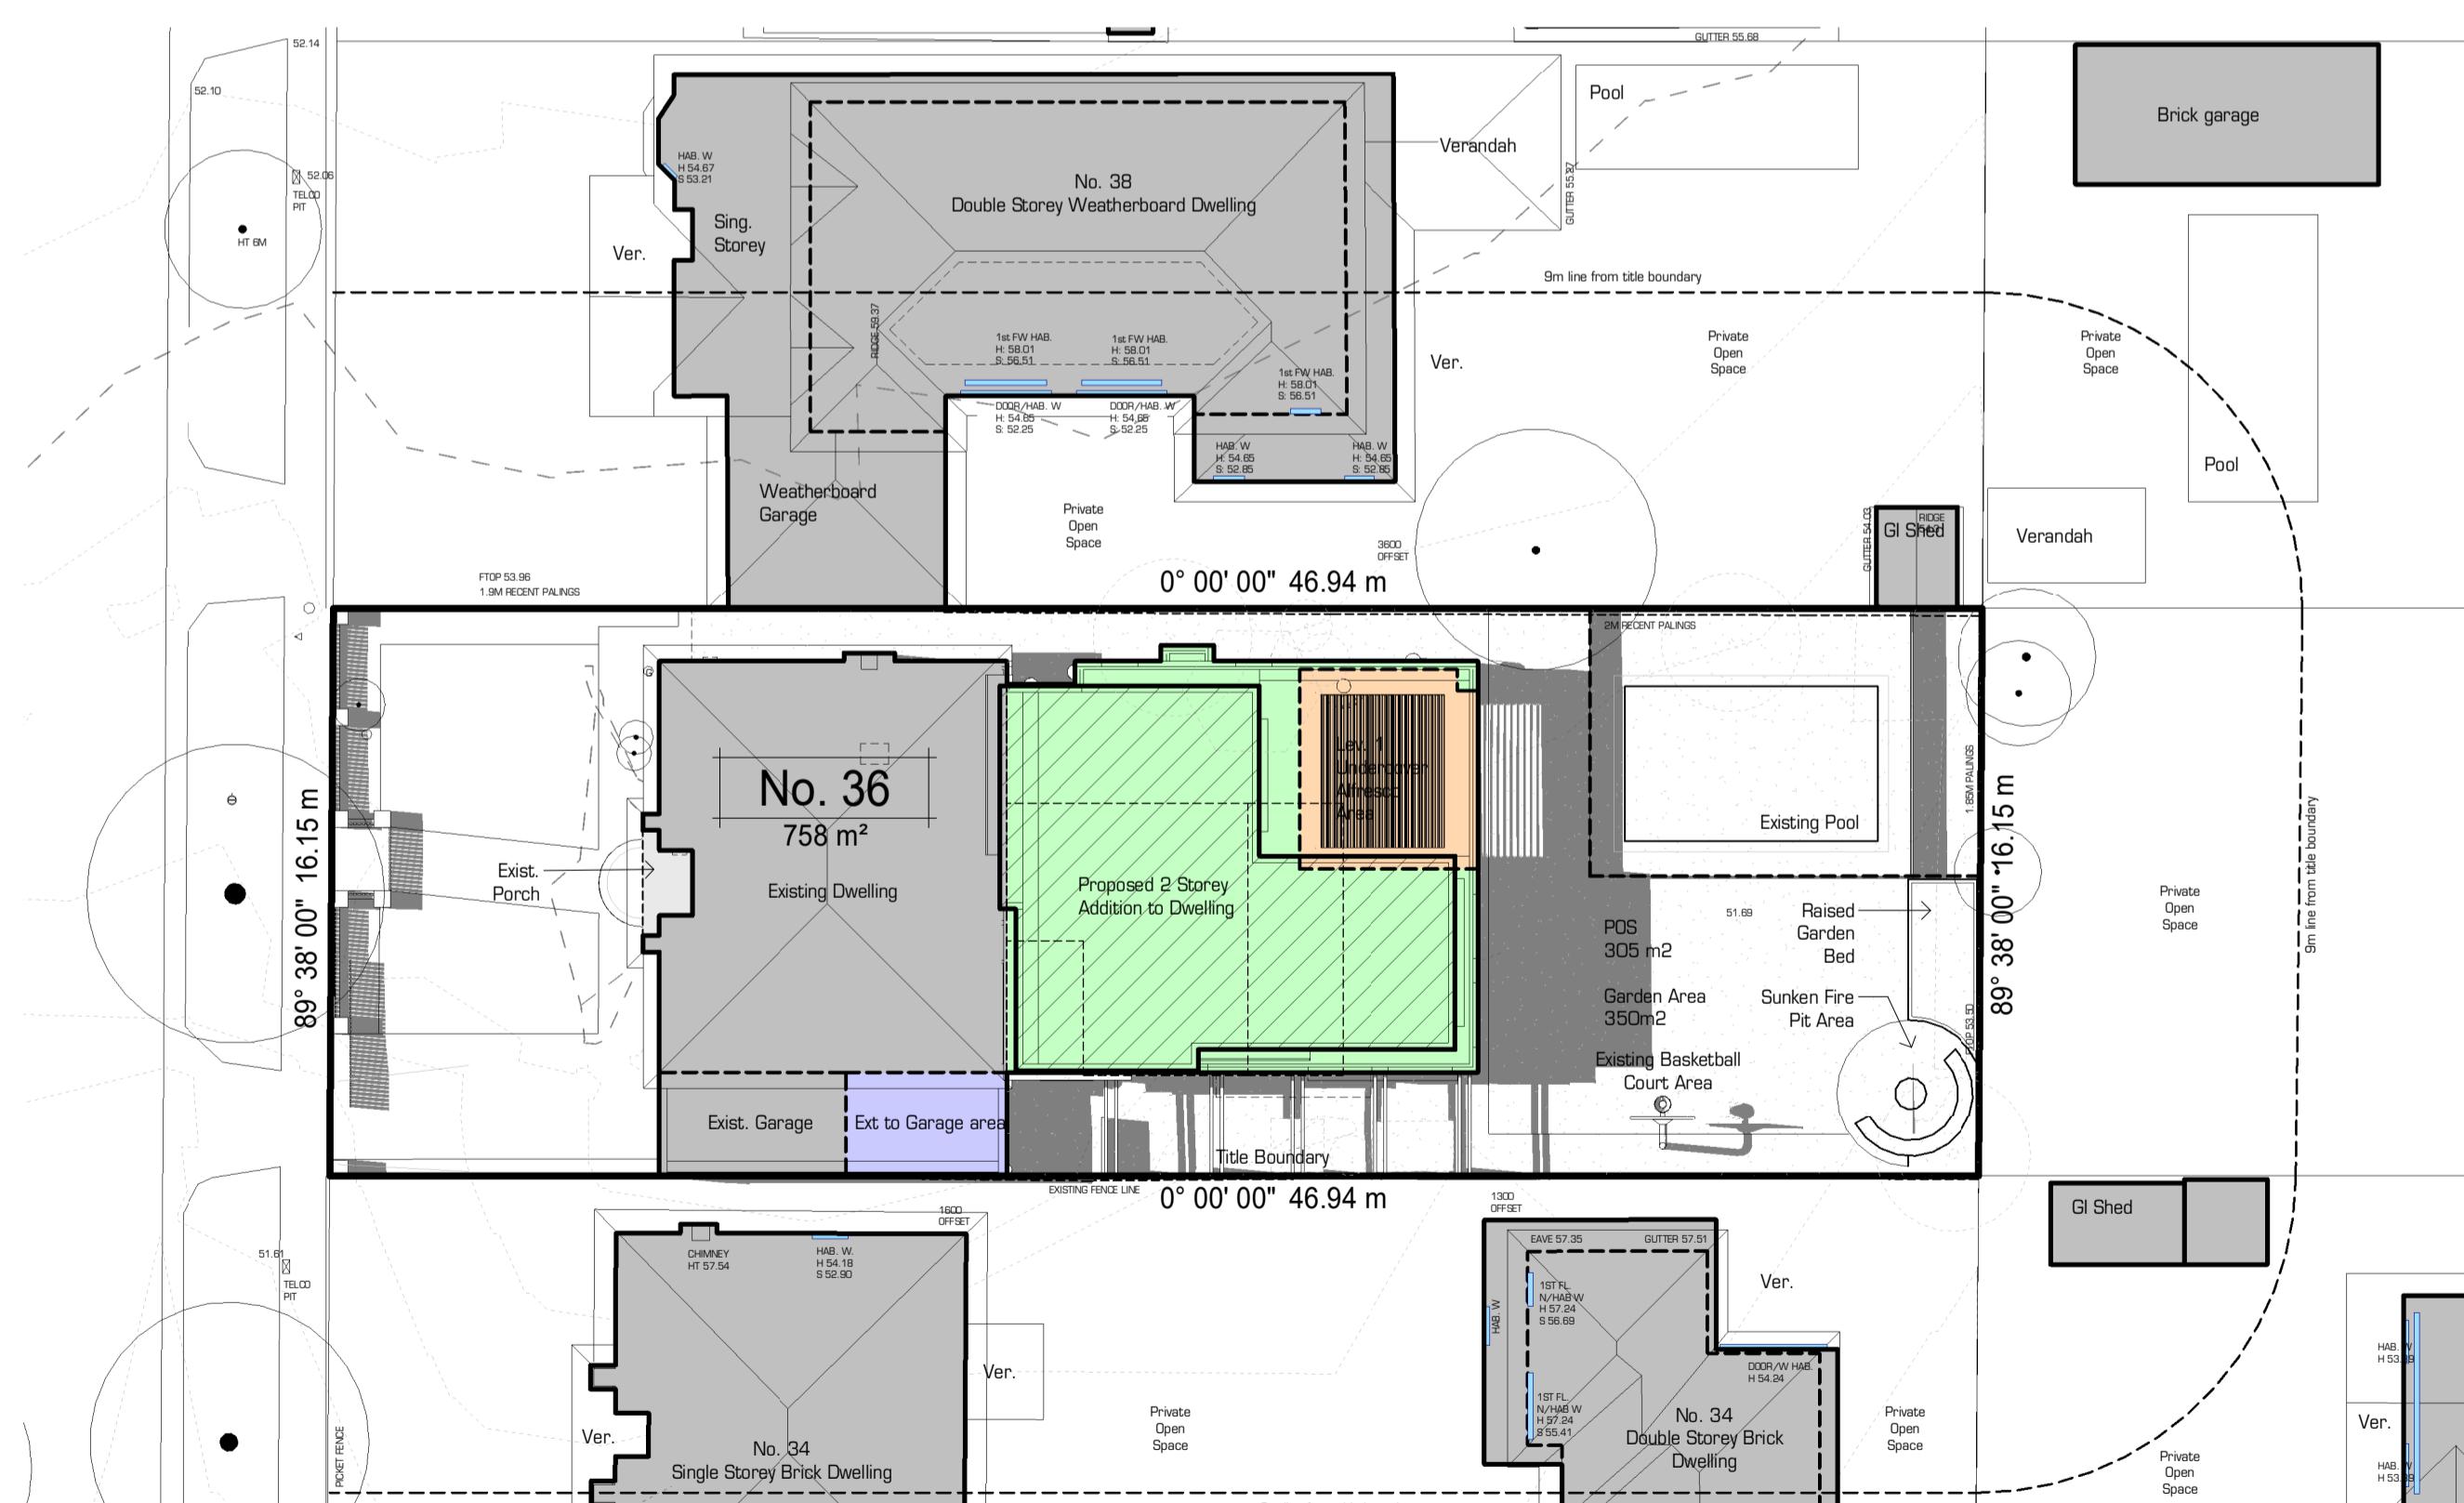

Shadow Plan - 12pm

SCALE 1 : 200

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Lot:
PS:
Parish:
Volume:
Folio:
Area:

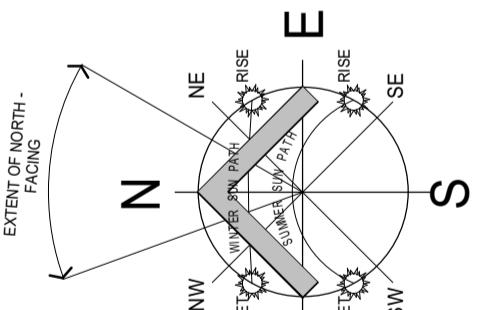Lot 105 (No. 36)
LP 6430
-
-
-
758 m²

Rescode Legend:

- SPOS** LOCATION OF NEIGHBOURING SHELDED PRIVATE OPEN SPACE
- POS** LOCATION OF RECREATIONAL PRIVATE OPEN SPACE
- PO** LOCATION OF PRIVATE OPEN SPACE 25m² MIN
- PS** LOCATION OF PERMEABLE SURFACE
- HAB** LOCATION OF NEIGHBOURING HABITABLE ROOM WINDOW
- NH** LOCATION OF NEIGHBOURING NON HABITABLE ROOM WINDOW

No.	Revision Description	Date:

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Shadow Diagrams

CLIENT / PROJECT: SABA ADDITION PROJECT:
ADDRESS: No. 36 Calebeena Road,
Hughesdale Victoria 3166
DATE: 9 January 2023

ORIGINAL SHEET SIZE: A1 \\\DAWESDESIGNNAS Drive 1\1 - Master Revit Files\81 - 19 September 2024\2R49 - Sabah (Hinchesdale) 2R49 - Town Planning Issue - G - 006 [change to done] DWT


Existing Floor Plan

SCALE 1 : 100



West Elevation (Exist.)


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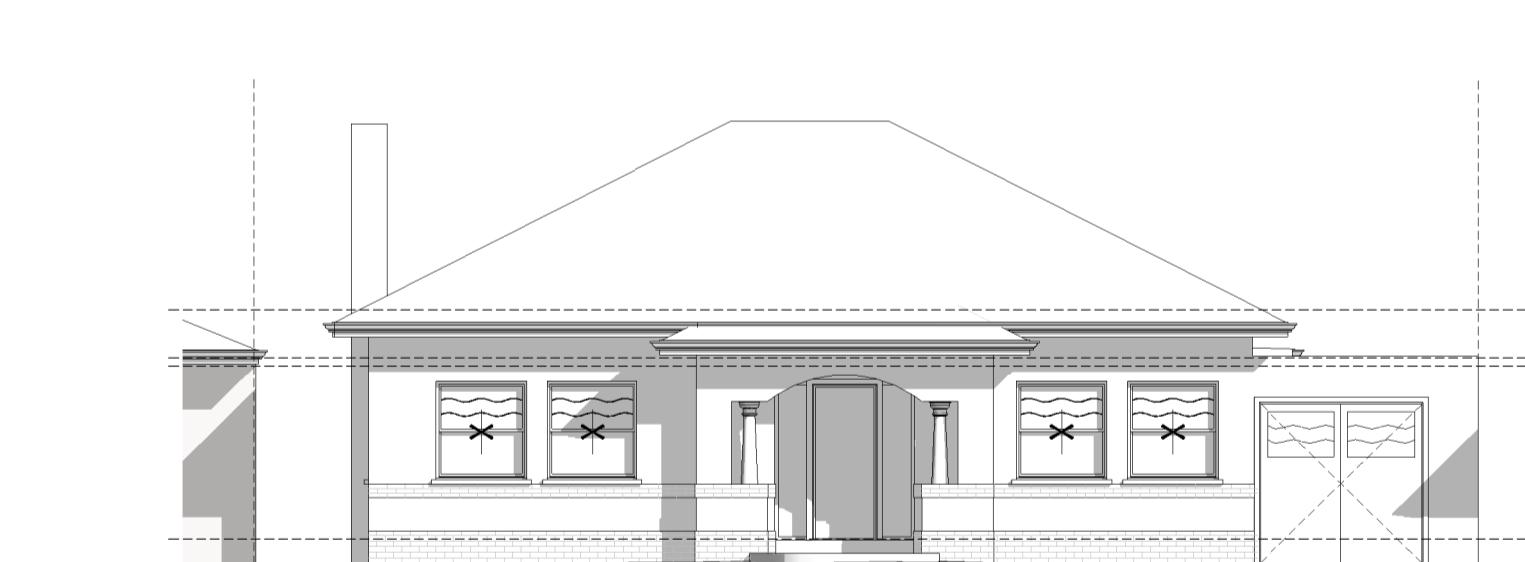
South Elevation (Exist.)

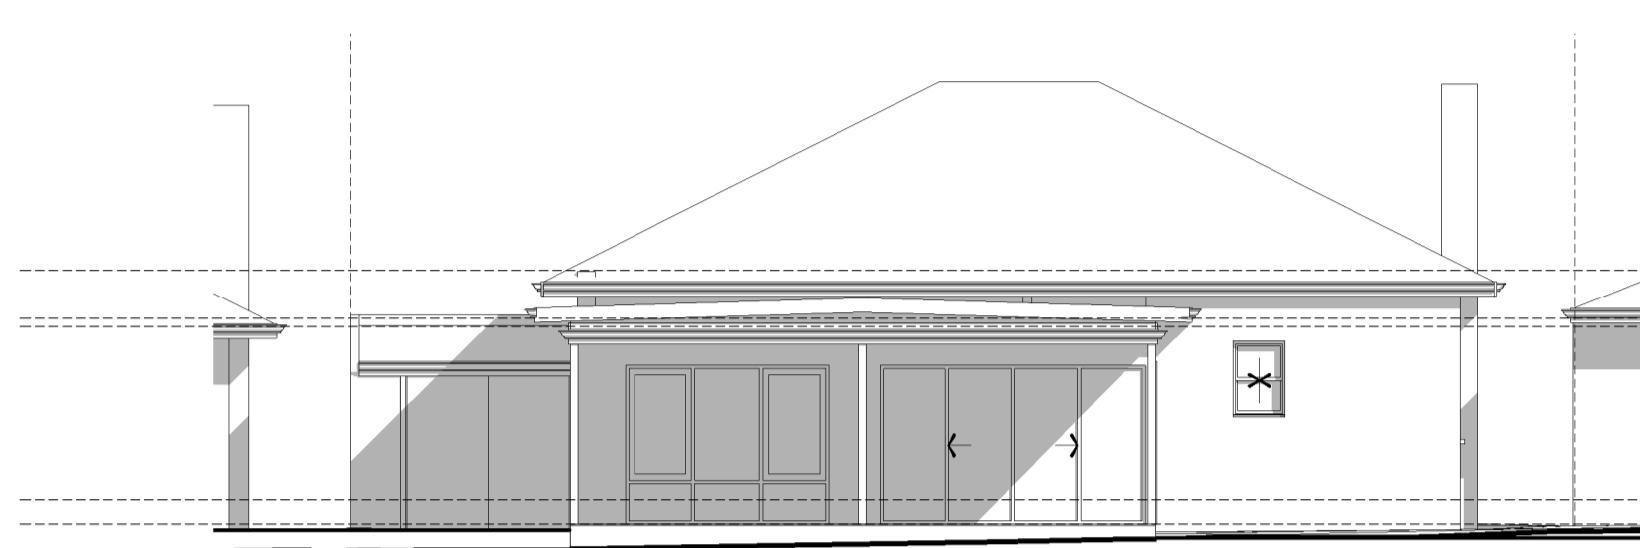SCALE 1 : 100




East Elevation (Exist.)

SCALE 1 : 100

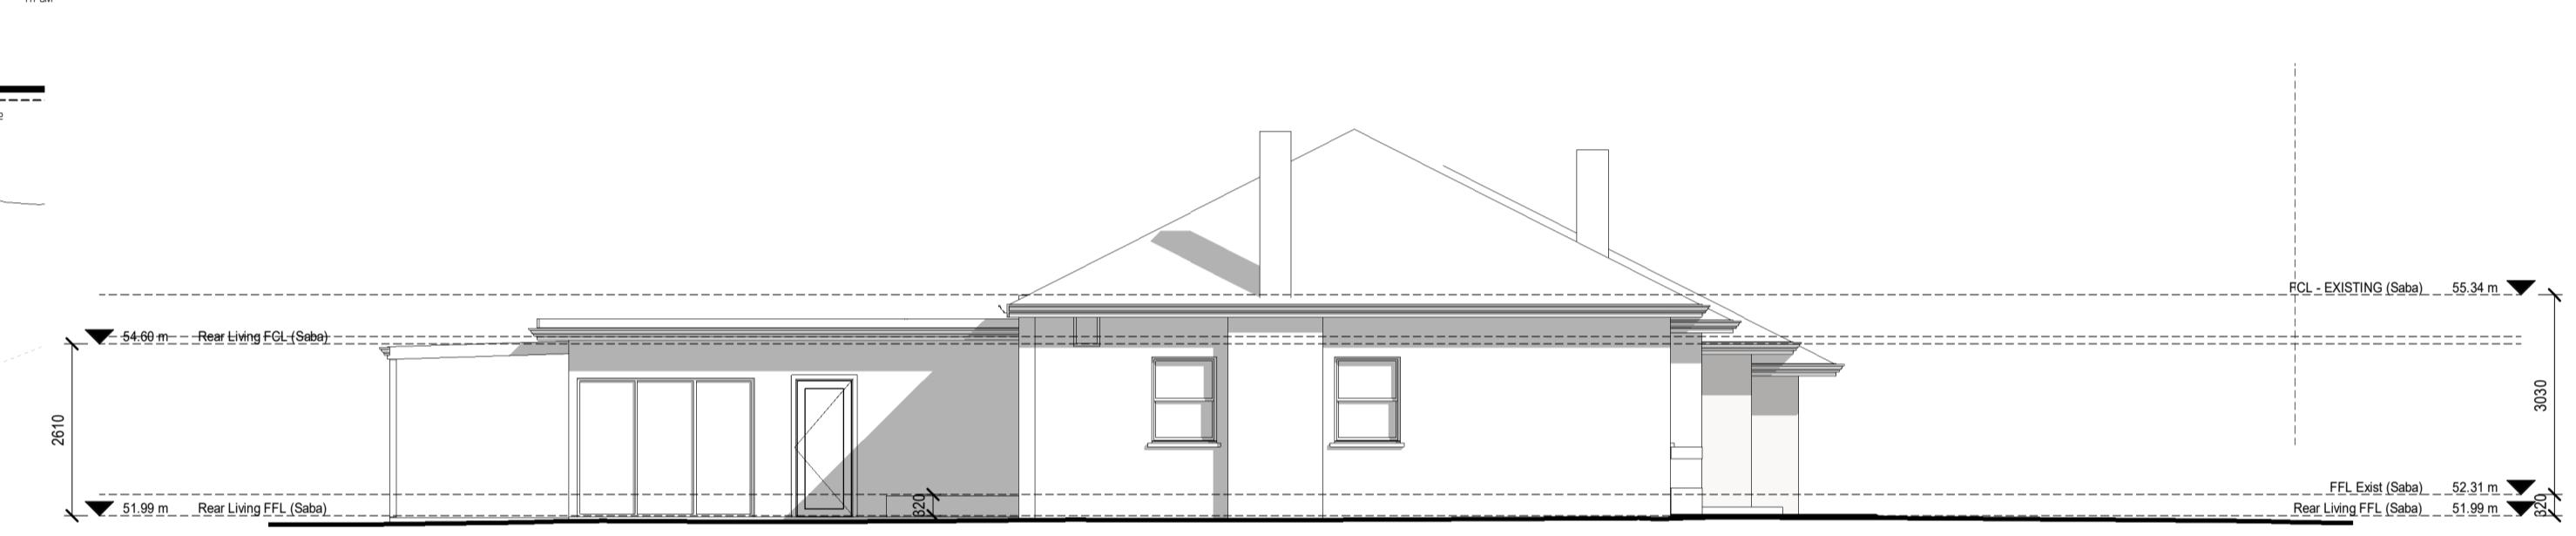

North Elevation (Exist.)

SCALE 1 : 100

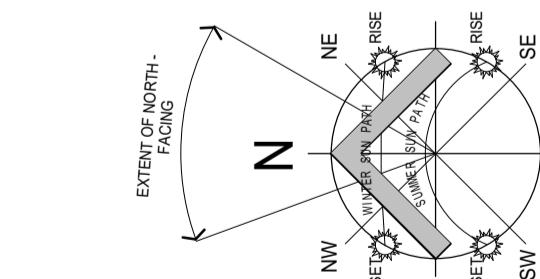

These drawings shall be read in conjunction with all relevant structural and all other consultants drawings/details and with any other written instructions issued in the course of the contract.

Wall Legend:

EXISTING WALLS TO REMAIN

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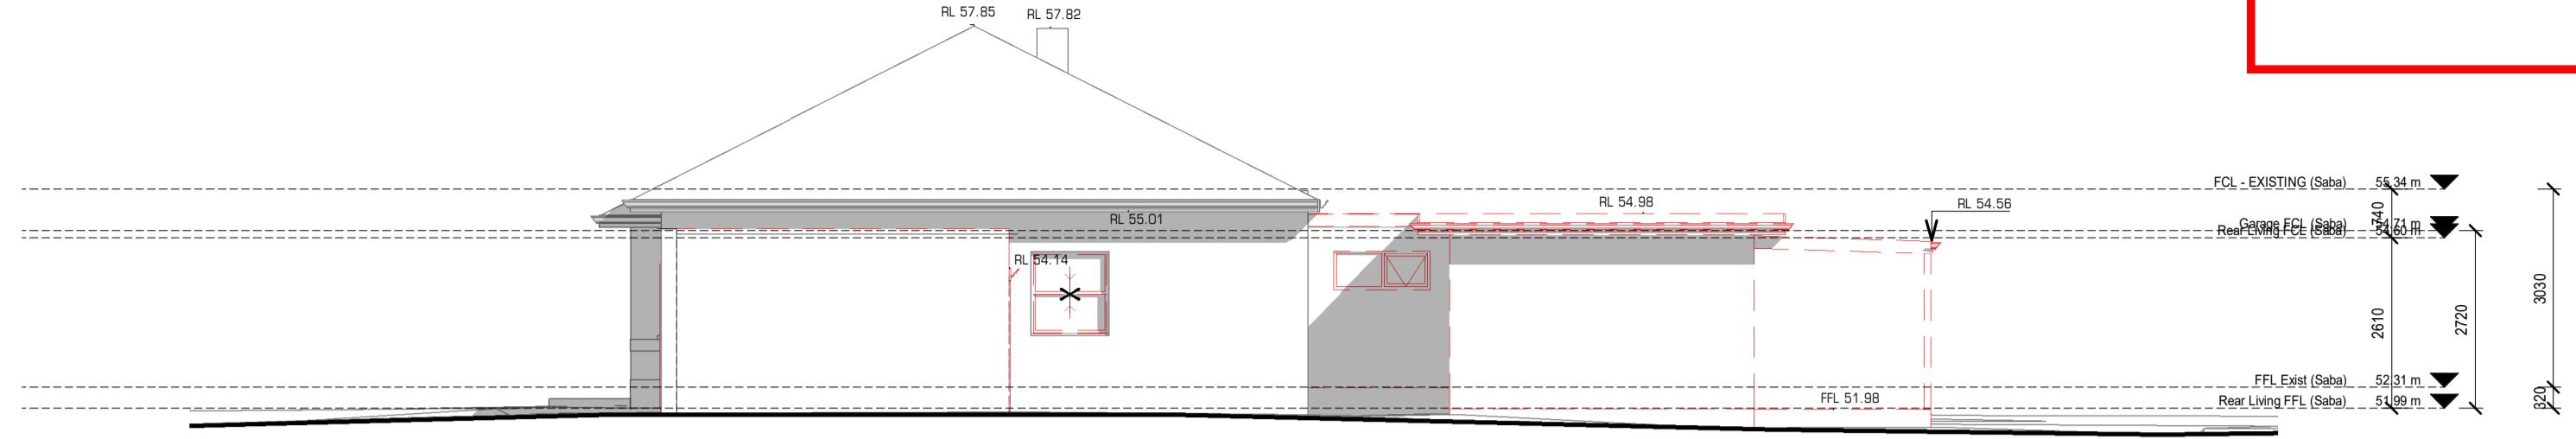
DESIGN & DRAFTING GROUP

P.O BOX 824 BERWICK, VICTORIA 3806
CLIENT / PROJECT: SABA ADDITION PROJECT:
ADDRESS: No. 36 Calembeena Road,
Hughesdale Victoria 3166
DATE: 9 January 2023

DRAWING: Level 4 Existing & Demolition


Level 1 - Existing & Demolition

DESIGN:	Troy Dawes DP-AD 574	SHEET NO:
DWN BY:	Author	TPOE
DATE:	18/11/2024 10:28:23 AM	JOB NO:
SCALE:	1 : 100	2649




West Elevation (Demo.)

SCALE 1 : 100

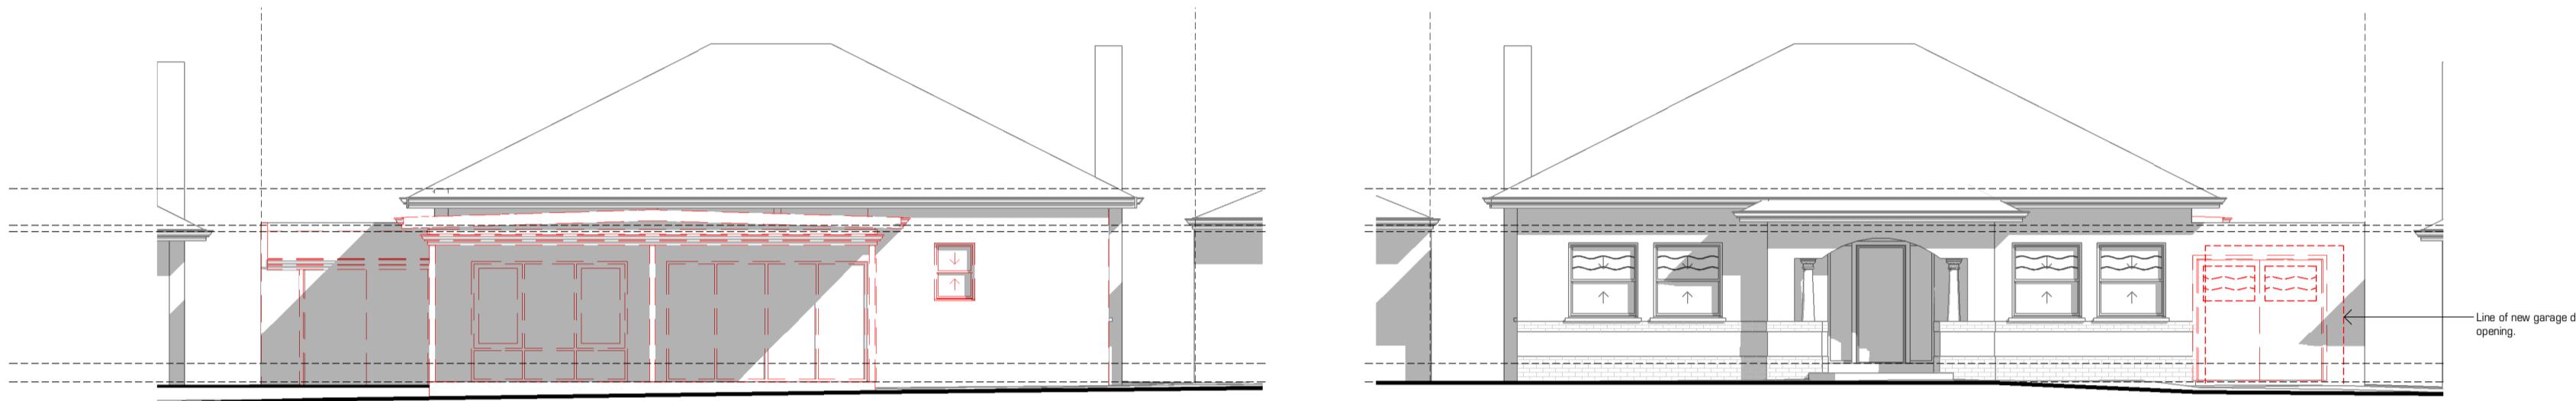


South Elevation (Demo.)

SCALE 1 : 100

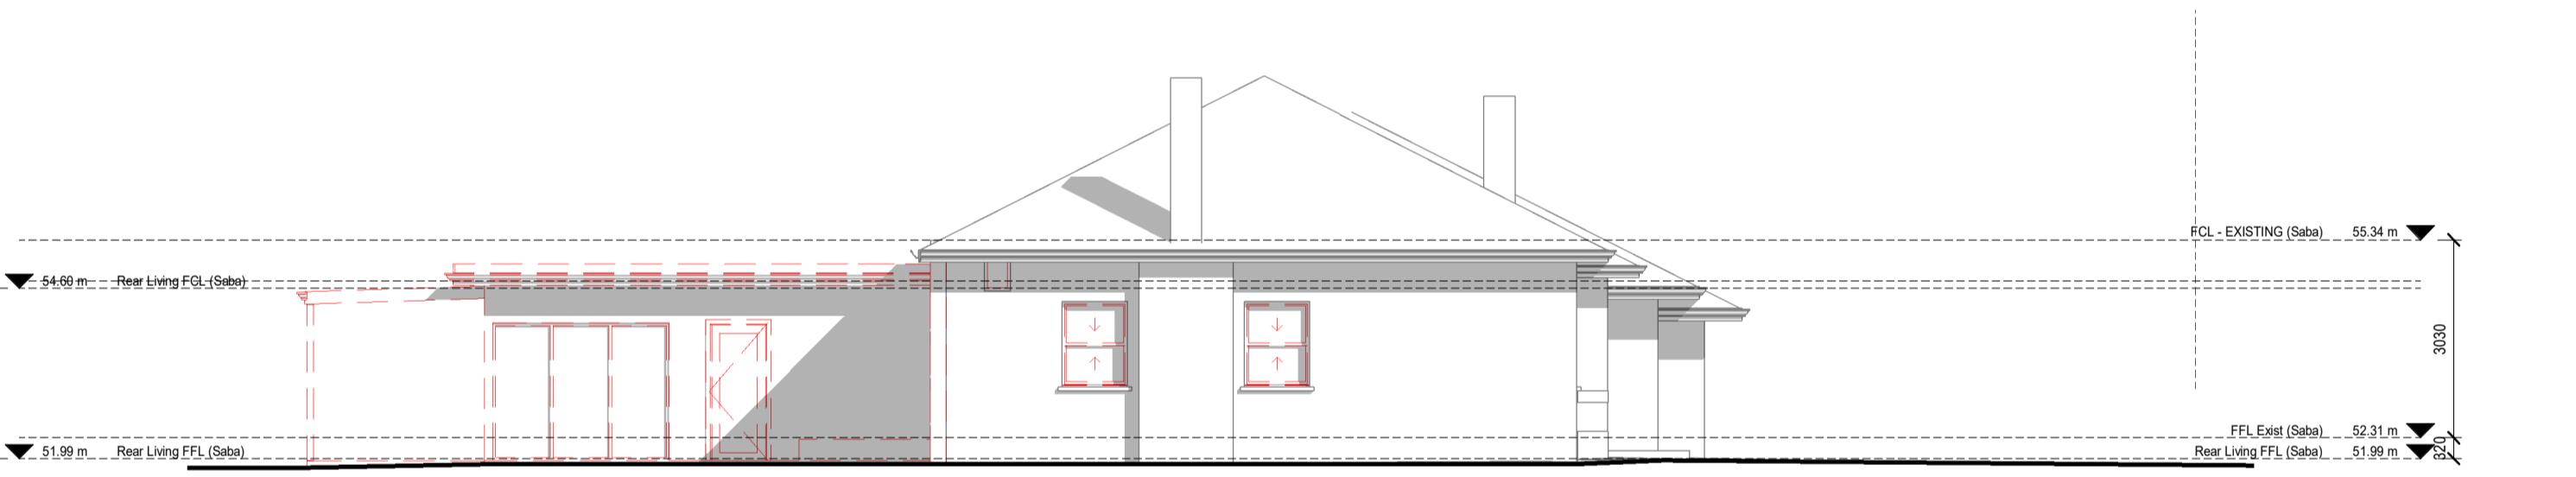

North Elevation (Demo.)

SCALE 1 : 100

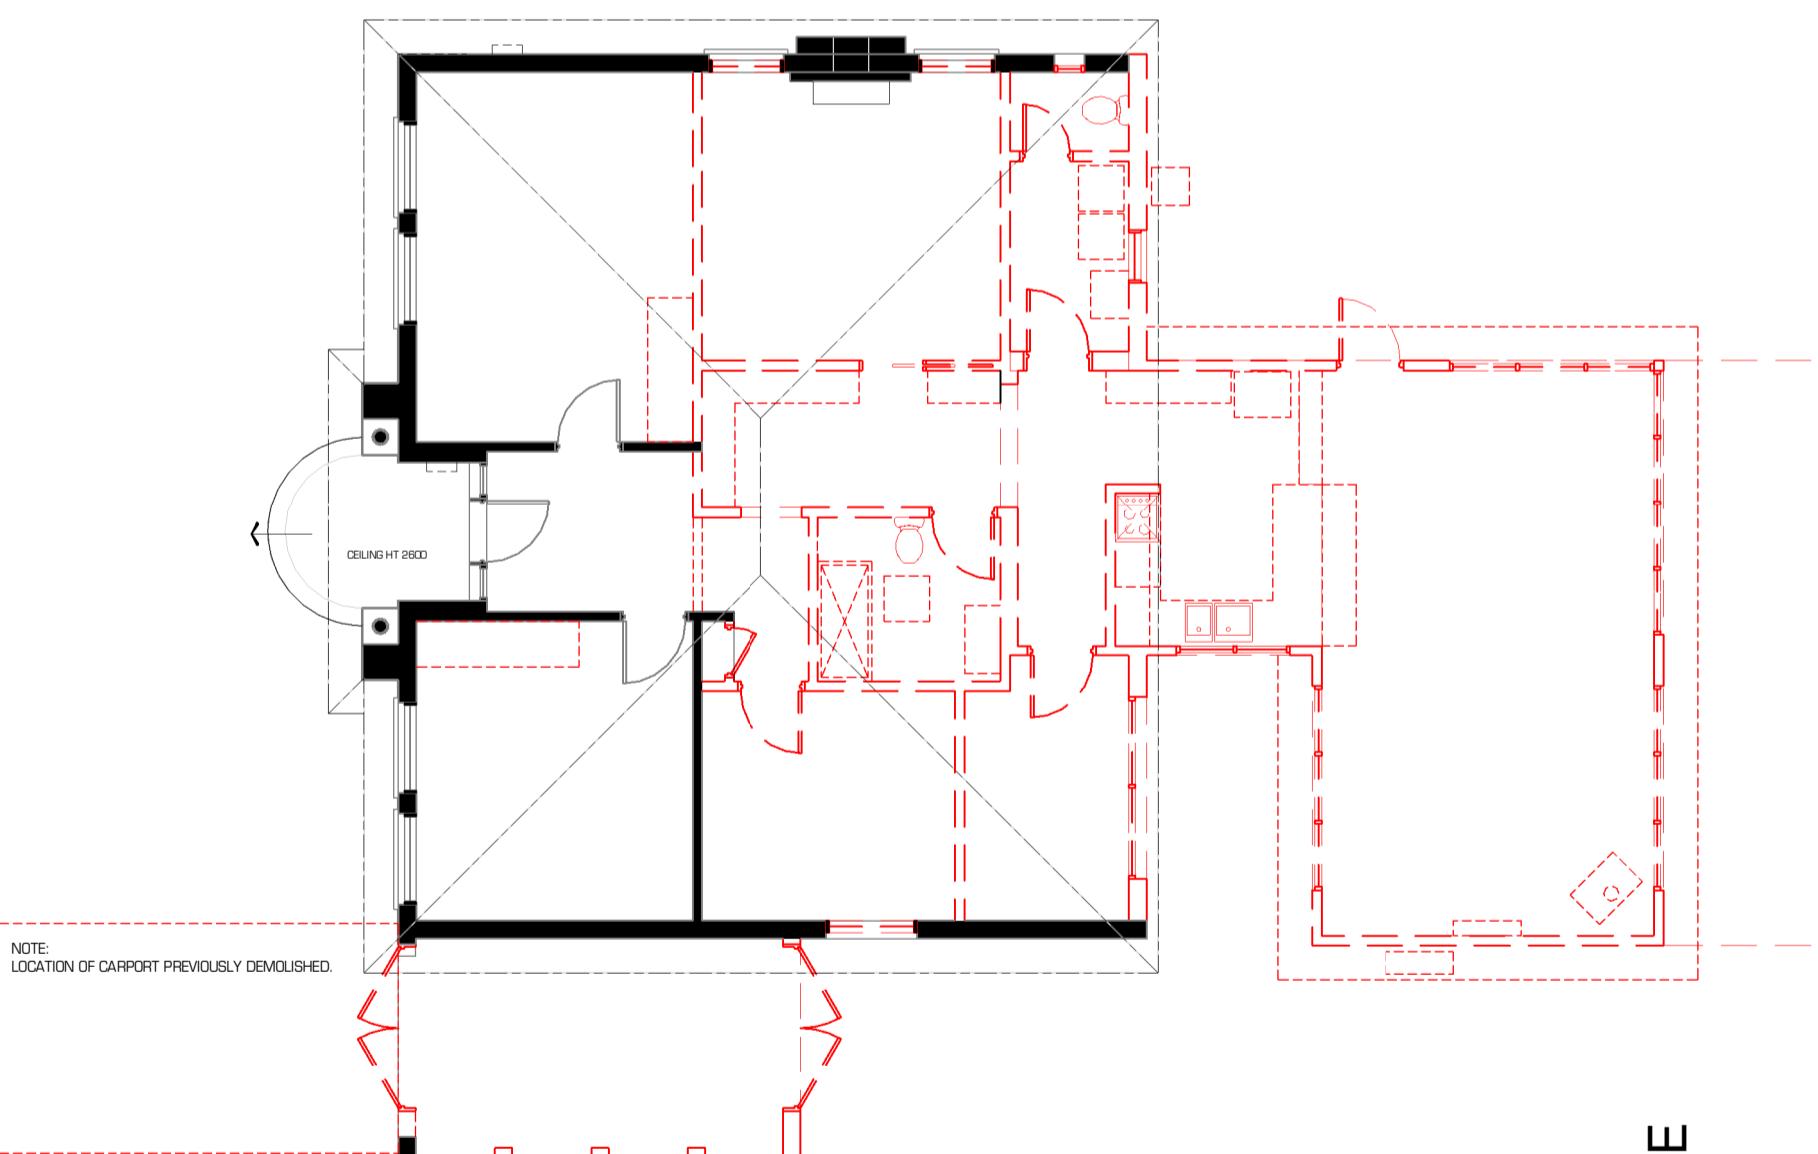

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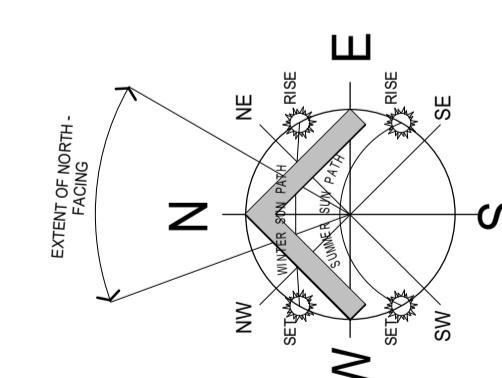
Figured dimension take precedence over stated dimensions. The Builder and Subcontractors shall check and verify all dimensions, setbacks, levels and specifications and all other relevant documentation prior to the commencement of any works. Report all discrepancies to the office for clarification.

Level 1 - Demolition

SCALE 1 : 100

Wall Legend:

— EXISTING WALLS TO REMAIN.
- - - - - WALLS TO BE DEMOLISHED & MADE GOOD. REFER DEMOLITION NOTES.



Demolition Notes:

All materials and work practices shall comply with, but not limited to, the Building Regulations 2006, the Building Code of Australia and all relevant current Australian standards (as amended) referred to therein. These specifications specify only the minimum standard of work for the demolition works on residential projects, and all workmanship and precautions shall be best trade practice.

Precautions must be taken before and during demolition in accordance with AS 2601-2001: Demolition of Structures.

During the progress of the demolition the works shall be under the continuous supervision of the Demolisher or an experienced foreman, and demolition shall be executed storey by storey commencing at the roof and working downwards.

The demolition must not be commenced until the precautionary measures have been inspected and approved by the Relevant Building Surveyor.

The Demolisher shall construct a temporary crossing placed over the footpath, as required by the Council.

Protective outriggers, fences, swing, hoisting, bermeades and the like must be installed where necessary to guard against danger to life or property or when required by the Relevant Building Surveyor.

Dust creating material, unless thoroughly dampened down, shall not be thrown or dropped from the building but shall be lowered by hoisting apparatus or removed by material chutes. All chutes shall be completely enclosed and a danger sign shall be at the discharge end of every chute.

All practicable precautions shall be taken to avoid danger from collapse of a building when any part of a framed or partly framed building is removed.

Demolished material shall not be allowed to remain on any floor or structure if the weight of the material exceeds the safe carrying capacity of the floor or structure, and such material shall not be so piled or stacked that it will endanger workers or other persons, and shall be removed as soon as practicable from the site.

No wall, chimney or other structure or part of a structure shall be left unstranded or unsupported in such a condition that it may collapse due to wind or vibration or otherwise become dangerous.

Before demolition is commenced, and also during the progress of such works, all electrical cable or apparatus which are liable to be a source of danger - other than cable or apparatus used for the demolition works - shall be disconnected.

Arrangements shall be made with the Relevant Electrical Supply Authority for the disconnection of electrical mains supply except that, where partial demolition is proposed, the licensed Electrical Contractor shall satisfy the Relevant Electrical Supply Authority that the portion of the building to be demolished has been isolated.

The Demolisher shall be responsible for the disconnection of all telecommunication supply.

The Demolisher shall be responsible to cut and seal any storm water, sewer pipes, water services, gas services and the like.

The position of capped sewer and storm water drains, seekoff water supply lines, gas supply lines and the like are to be clearly marked on the site.

Materials removed or displaced from the building shall not be placed in any street, road or right of way and, before commencing, where required, shall be kept sprayed with water so as to prevent any nuisance from dust.

Materials removed or displaced from the building being demolished or materials left standing shall not be burned on the demolition site.

Removal of building by road must be approved by Relevant Council Traffic Engineer.


A site management plan is to be implemented during demolition works to control sediment runoff in accordance with EPA Victoria publication #275: Construction Techniques for Sediment Pollution Control - Provide 'proper' or equivalent silt fences to the low side of the allotment and around all soil stockpiles and storm water inlet pits/sumps and install 'tie-down' fibre bags over all storm water entry pits during demolition works. 'Superior' or equivalent erosion control fabric is to be placed over garden beds to prevent surface erosion during reseeding period.

It is the builder's responsibility to carry out an audit prior to the commencement of any works to determine if asbestos is present in the existing works. Where any asbestos product is found in the proposed works area during initial inspection or during the course of the demolition works the builder shall engage an authorised and registered contractor for safe removal and lawful disposal.

No.	Revision Description	Date:

ROAD

C A L E M B E E N A

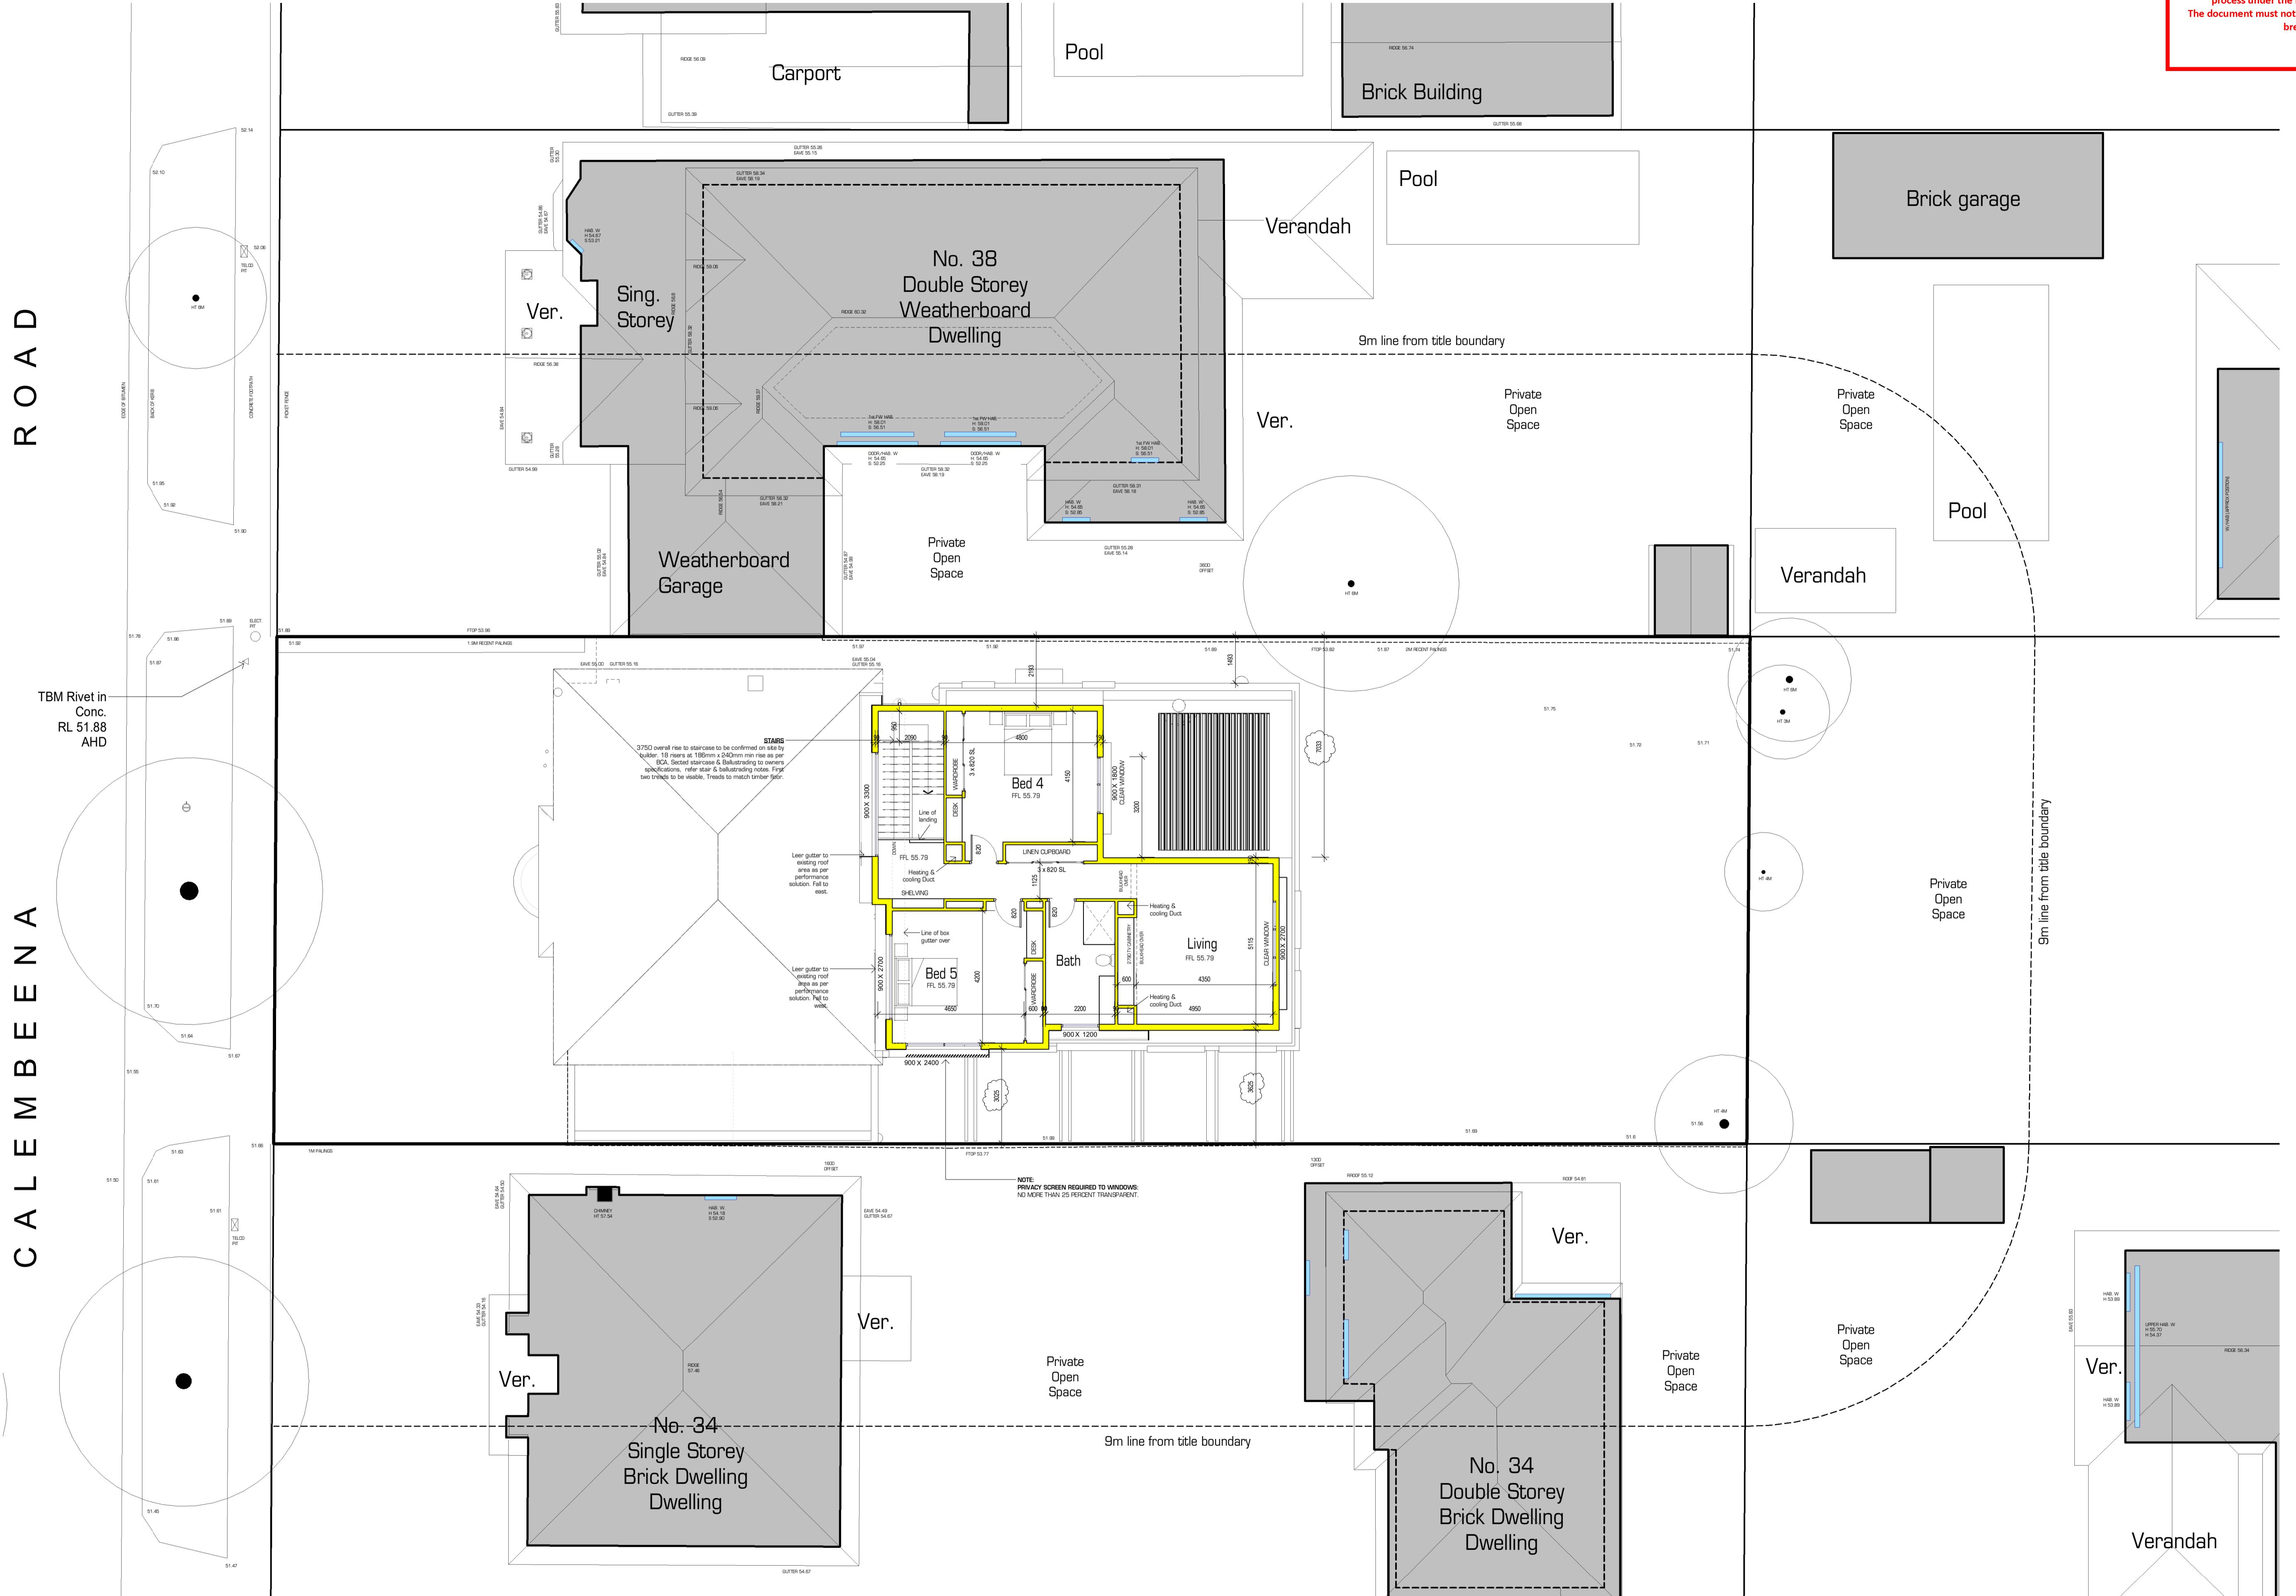

Level 2 - Proposed

SCALE 1 : 100

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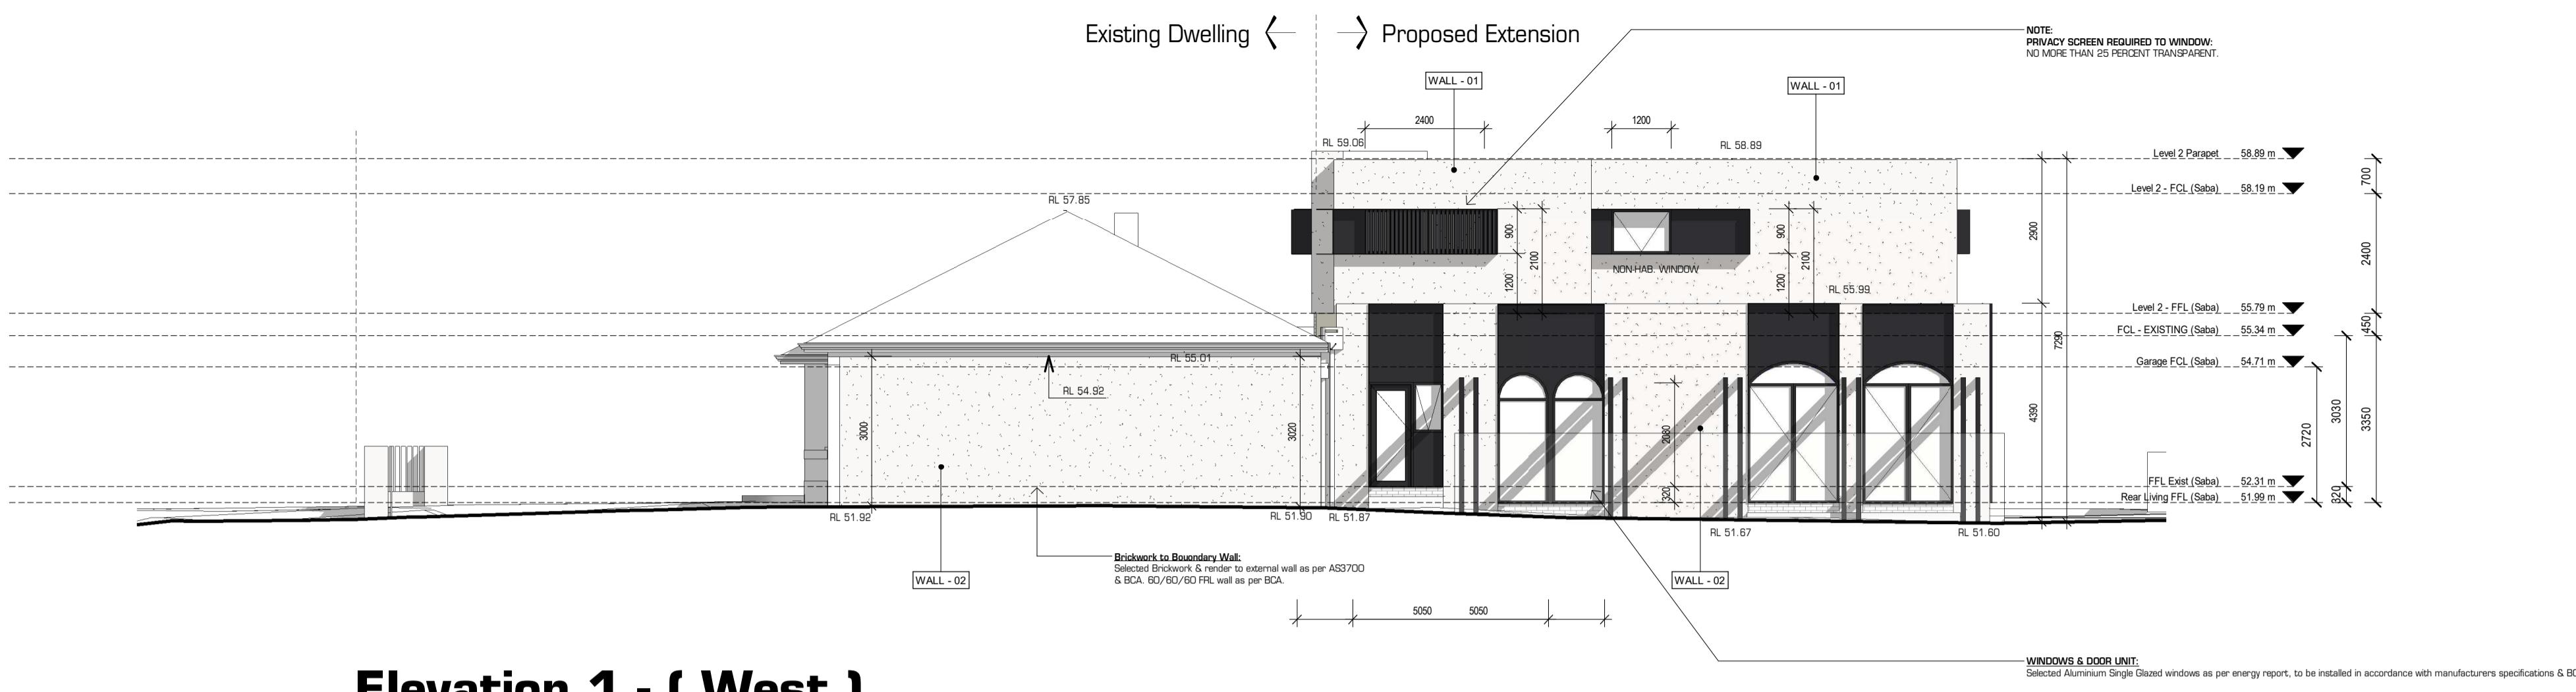
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DESIGN & DRAFTING GROUP

CLIENT / PROJECT: **SABA ADDITION PROJECT:**
ADDRESS: No. 36 Calembeena Road,
Hughesdale Victoria 3166
DATE: 9 January 2023


113 BOX SE 1/ BENTWICK, VICTORIA 3166 113 36 CALEMBEENA ROAD HUGHESDALE VICTORIA 3166 DRAWING: Level 2 - Proposed Floor Plan ISSUE: Town Planning Issue F - 14/11/2024

DESIGN: Troy Dawes DP-AD 574 SHEET NO: 1
DWN BY: Author
DATE: 18/11/2024 10:28:43 AM JOB NO:
SCALE: 1:100 2649




Elevation 1 - (West)

SCALE 1 : 100

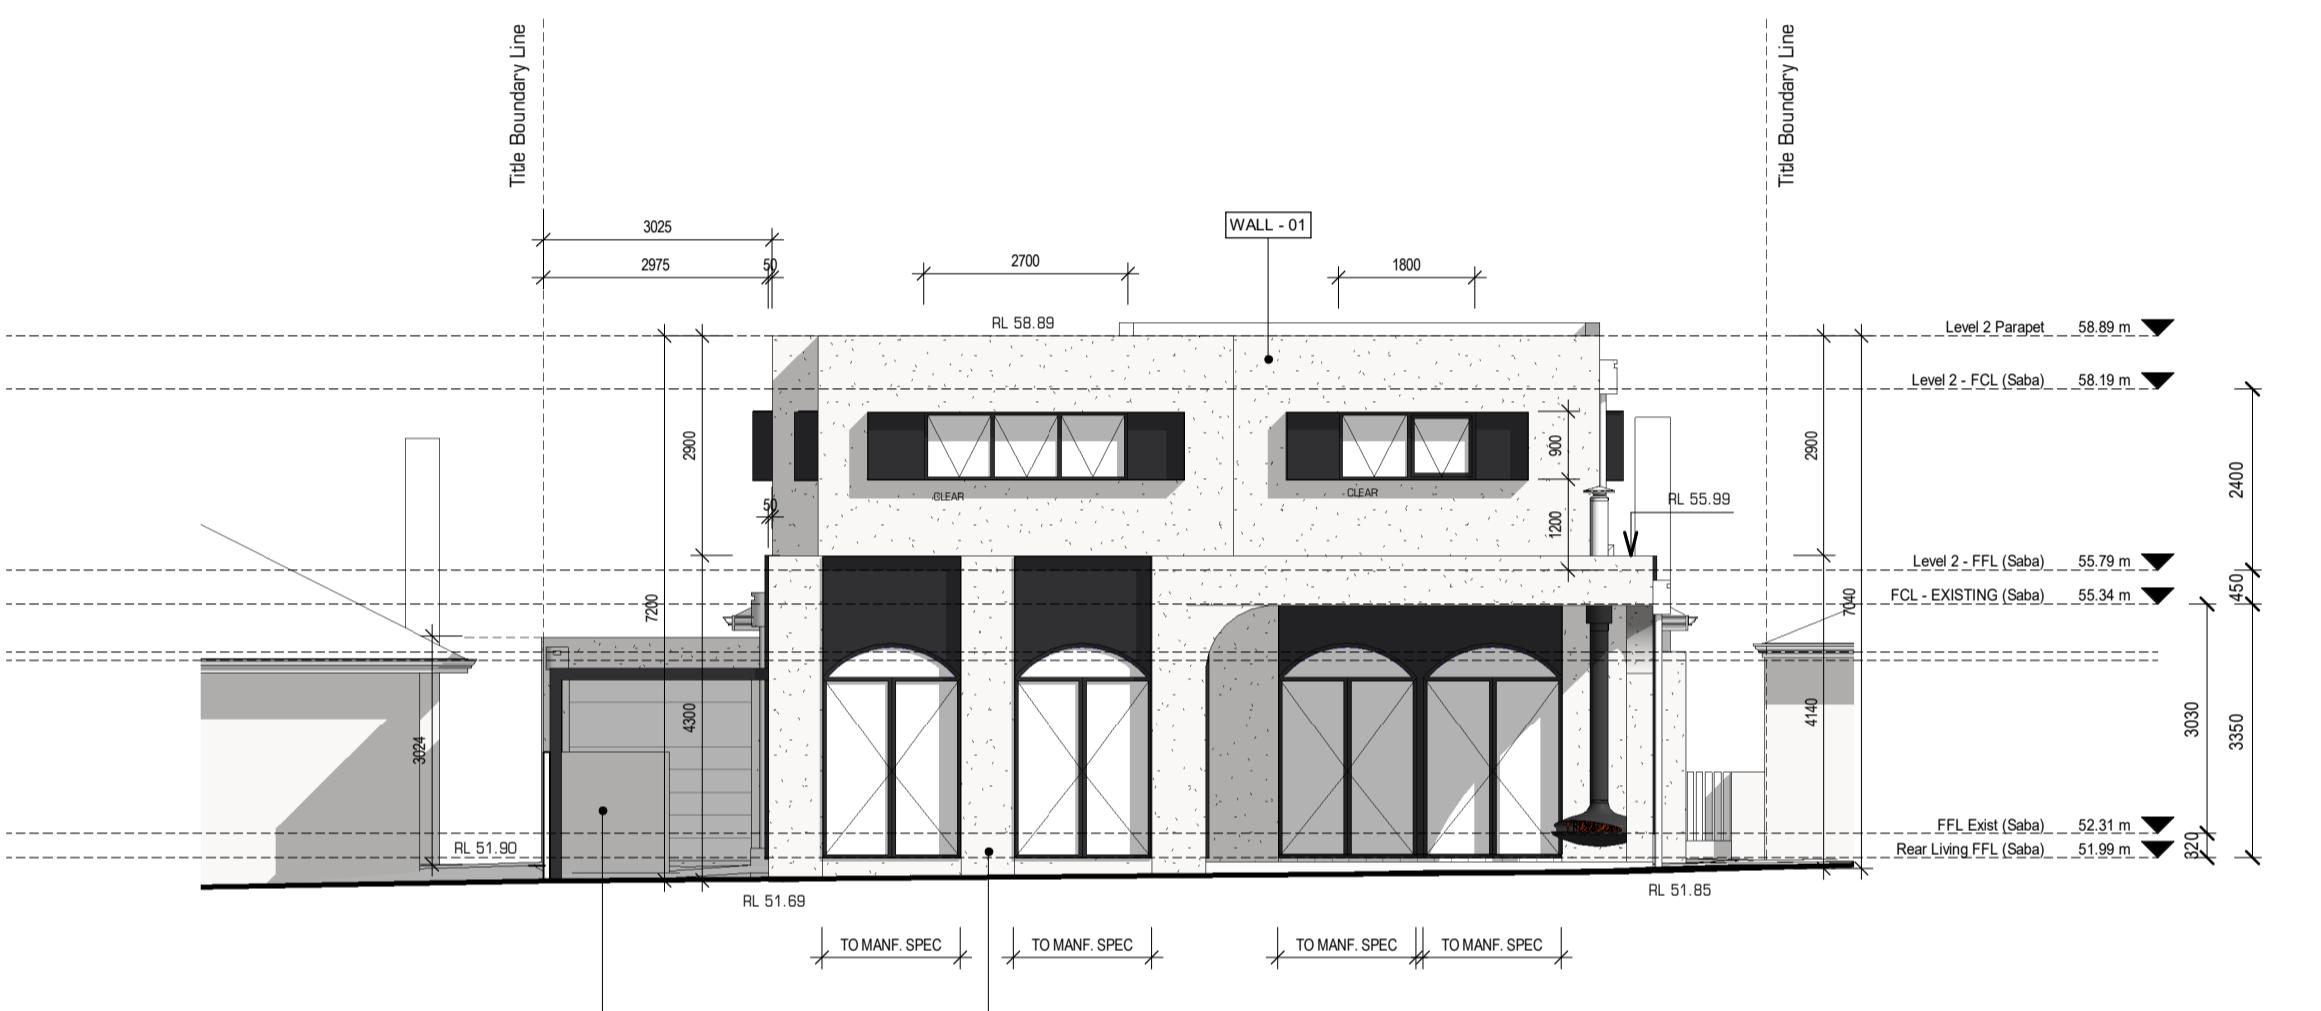

Elevation 2 - (South)

SCALE 1 : 100

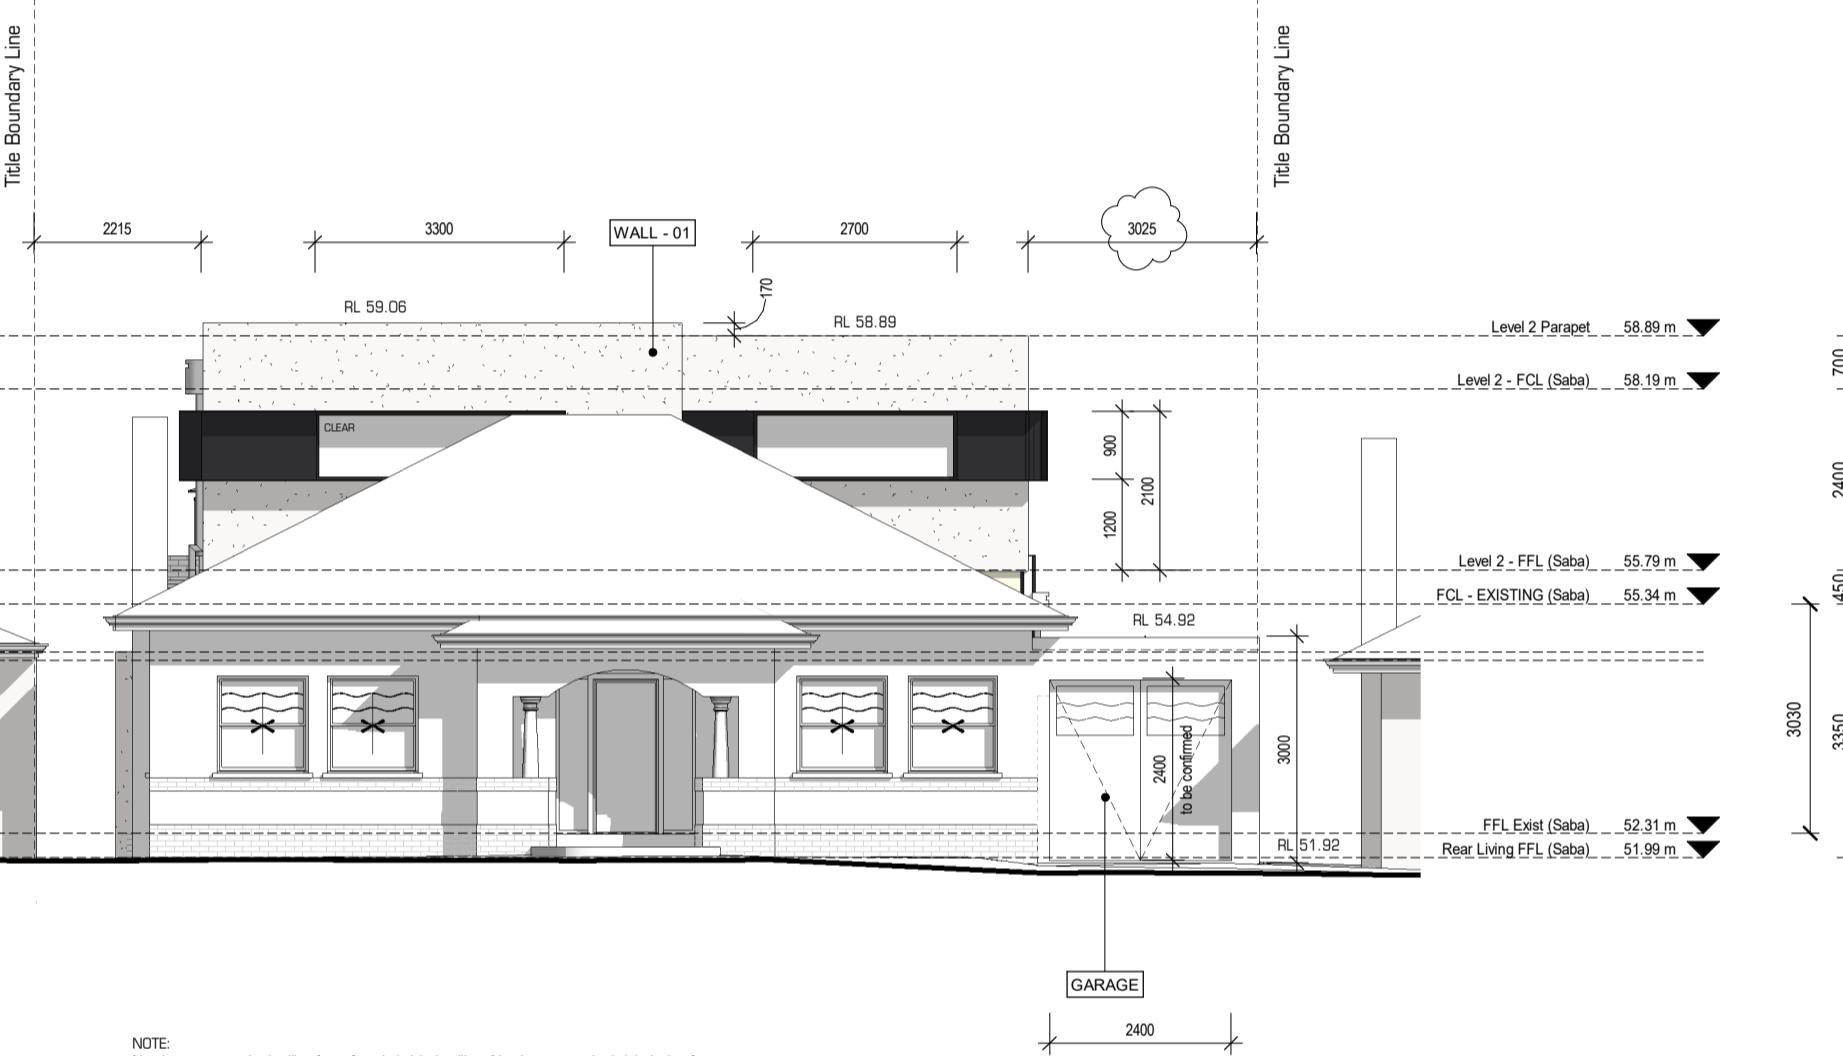

Elevation 4 - (North)

SCALE 1 : 100

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Elevation 5 - (Fence)


SCALE 1 : 100

Finishes Schedule:

WALL - 01	Level 2 NEW WALL CLADDING: STUCCO RENDER FINISH TO HEBEL PANELS INSTALLED AS PER MANUFACTURERS SPECIFICATIONS & NCC. COLOUR: STUCCO RENDER FINISH - COLOUR - DULUX CASPER WHITE QUARTER
WALL - 02	LEVEL 1 WALL CLADDING: STUCCO RENDER FINISH TO BRICKWORK TO BE INSTALLED AS PER AS3700 & NCC. Note: 60 / 60 / 60 FRL WALLS TO BOUNDARY AS PER DETAIL. COLOUR: STUCCO RENDER FINISH - COLOUR - DULUX CASPER WHITE QUARTER
ROOF - 01	NEW ROOF AREA TO LIVE 2: KILP LOK ROOF CLADDING - COLOUR TO OWNERS SPECIFICATIONS. MAIN ROOF PITCHED AT 1 DEGREE TBC. TO BE CONFIRMED ON SITE BY BUILDER. HIDDEN BEHIND RIV & GUTTERS TO MATCH ADJOINING WALL MATERIAL. COLOUR - SHALE GREY, TO OWNERS SPEC
WINDOWS	NEW WINDOWS: SELECTED ALUMINIUM WINDOWS, FRAMES & GLAZING TYPES REFER ENERGY PLAN & ENERGY REPORT, AS PER BCA REG. 3.12. COLOUR: DULUX METROPOLIS BRONZE PEARL
SHROUD	WINDOW SHROUD: PC STEEL WINDOW SHROUD. COLOUR: DULUX METROPOLIS BRONZE PEARL
ARBOR	WINDOW ARBOR: PC STEEL FEATURE ARBOR TO WEST FACE OF ADDITION. COLOUR: DULUX METROPOLIS BRONZE PEARL
SCREEN	WINDOW PRIVACY / SOLAR SCREENS: POWDERCOATED LOUvre SCREEN TO BE PROVIDED TO WINDOWS AS NOMINATED WITH SCREENS PERMANENTLY FIXED TO AT LEAST 1.7M ABOVE FLOOR LEVEL AND BE NO MORE THAN 25 PERCENT TRANSPARENT. COLOUR: DULUX METROPOLIS BRONZE PEARL
GARAGE	NEW GARAGE DOOR: SELFRIGHT UPRIGHT GARAGE DOOR. SIMILAR TO EXISTING GARAGE DOOR. TO MAINTAIN THE ORIGINAL DESIGN INSTALLED AS PER MANUFACTURERS SPECIFICATION. COLOUR: SURFMIST TO OWNERS SPEC
GARAGE - 2	NEW GARAGE DOOR: SELECTED PANEL LIFT GARAGE DOOR. INSTALLED AS PER MANUFACTURERS SPECIFICATION. COLOUR: SURFMIST TO OWNERS SPEC


CLIENT / PROJECT: SABA ADDITION PROJECT:
ADDRESS: No. 36 Calmbeena Road,
Hughesdale Victoria 3166
DATE: 9 January 2023

DRAWINGS: **Elevations & Finishes Schedule**
ISSUE: Town Planning Issue F - 14/11/2024

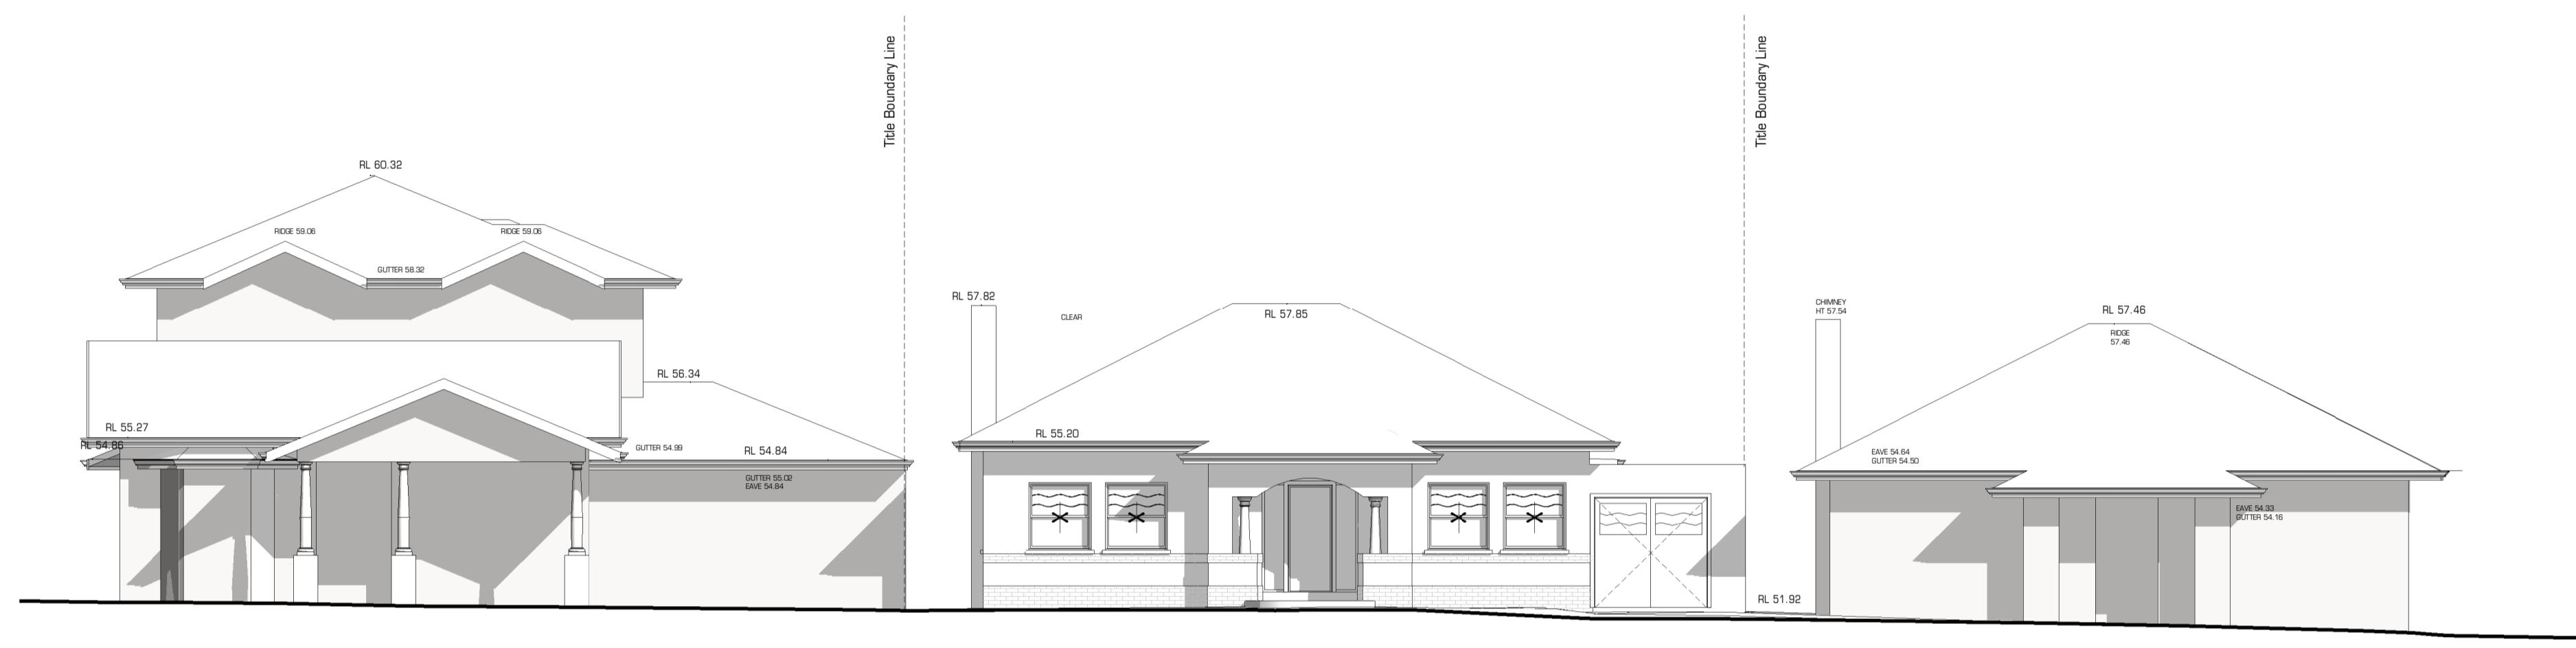

Streetscape Elevation - Existing

SCALE 1 : 10

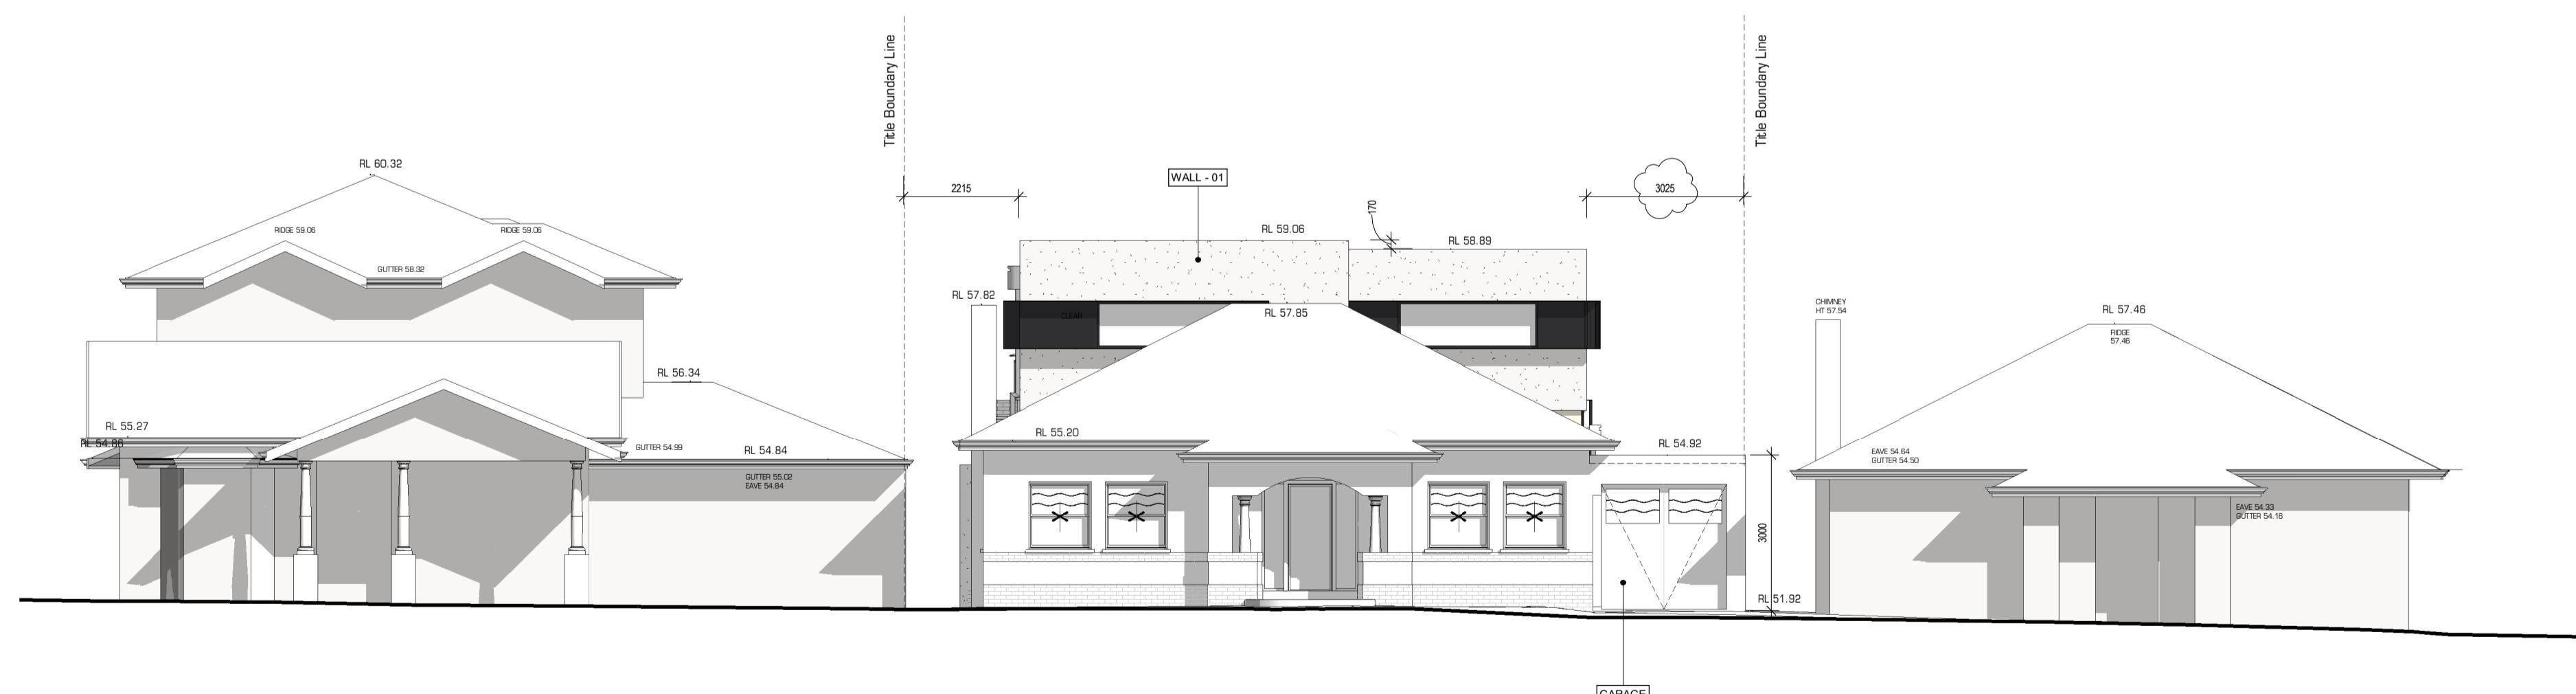

Streetscape Elevation - Proposed

SCALE 1 : 10

